IOWN OF DELHI, NEW YORK

MUNICIPAL SWIMMING POOL & BATHHOUSE PROJECT

MAIN STREET

DELHI, NEW YORK

DELAWARE COUNTY

- FENCE & ENTRANCE WAY SHALL HAVE SELF-CLOSING AND POSITIVE SELF LATCHING LOCKABLE GATES. . LATCH LOCATION TO BE PER NYSDOH (NEW YORK STATE DEPT. OF HEALTH) REQUIREMENTS.
- a. DEPTH MARKING AT WALL OR DECK, SPACED NOT MORE THAN 25 FEET AT 2' INCREMENTS OF DEPTH MAXIMUM. MINUMUM POINT, BREAK POINT.
- NUMERAL HEIGHT 4 INCHES OR MORE. COLOR CONTRASTING WITH BACKGROUND.
- FLOAT LINE AT 5 FEET BREAK POINT.
- e. 4 INCH STRIPE OF CONSTRASTING COLOR AT BREAKPOINT OR 5 FOOT DEPTH & ON STEPS OR
- 4. LIFEGUARD CHAIRS ARE TO BE ADEQUATE AND LOCATION ACCEPTABLE TO NYSDOH, 2 REQUIRED
- 5. LIFE SAVING EQUIPMENT PROVIDE MIN. 2 UNITES OF (A) & (B) BELOW.
- a. TORPEDO BUOY AND RESCUE TUBE WITH A 6 FOOT LINE, RING BUOY AT LEAST 18 INCHES IN DIAMETER, FITTED WITH 1 INCH DIAMETER LINE WITH A LENGTH OF 1.5 TIMES THE MAXIMUM WIDTH OF POOL OR 50 FEET. WHICHEVER IS LESS
- ONE REACHING POLE 15 FEET LONG
- c. COMMERCIALLY AVAILABLE FIRST AID KIT, SEE SPECS. FOR CONTENTS

DEPTH MARKINGS

- SEE DWG. SW-1, SAFETY EQUIPMENT TABLE FOR ADDITIONAL REQUIREMENTS
- LIGHTING AND ELECTRICAL
- WIRING CONFORMS TO NATIONAL ELECTRICAL CODE.
- b. POOL AND METAL FIXTURES PROPERLY GROUNDED.
- NO OVERHEAD ELECTRICAL WIRING WITHIN 20 FEET OF POOL
- d. GROUND FAULT INTERRUPTERS PROVIDED AT BATHROOMS & EXTERIOR. 7. INTERCONNECTIONS
- a. WATTS 2" DCVA PROVIDED ON FILL PIPE/DRAIN PIPE.
- b. APPROVED BACKFLOW PREVENTER INSTALLED ON PUBLIC W.S.(1' AIRGAP TO GRADE) c. WATER SUPPLY MEETS PART 5 OF CODE.
- 8. TURNOVER AND PIPING
- a. TURNOVER RATES ACCEPTABLE AT 4 TIMES EACH DAY. b. SUCTION LINE VELOCITY IS LESS THAN 6FT/SEC. (3FPS)
- c. PRESSURE LINES VELOCITY IS LESS THAN 10 FT/SEC. (6FPS)
- d. PIPING DETAILS SHOWN ON PLANS. (SCHEMATICS)
- e. PIPING COLOR CODED, SEE SPECS.
- 9. OVERFLOW SYSTEM
- a. GUTTERS PROVIDED (POOL GREATER THAN 2000SQ. FT).
- b. CAPABLE OF REMOVING 100% OF RECIRCULATION.
- c. SURGE CAPACITY ACCEPTABLE AT 5000 GALS.
- 10. DRAINS
- a. MINIMUM TWO DRAINS PROVIDED; EACH DESIGNED TO CARRY 100% OF THE RECIRCULATION FLOW. b. MAIN DRAIN(S) LOCATION IS ACCEPTABLE, 20' C.C. & 10' FROM WALL.
- c. SUCTION VELOCITY THROUGH GRATE IS LESS THAN 1.5 FT/SEC.
- d. WASTE TO DISCHARGE TO SANITARY SEWER
- a. MAKE AND MODEL#, PENTAIR CH-75, CAPACITY 380 @ HEAD 64 FT.
- b. PUMP CURVES AND EAD LOSS CALCULATIONS ATTACHED.
- c. PRESSURE GAUGES PROVIDED.
- d. FLOW METER 4" MAGNETIC FLOW METER
- e. LOCATION OF FLOW METER IN STRAIGHT RUN OF PIPE
- f. RATE OF FLOW CONTROLLERS OR WAFER VALVE TO BE PROVIDED. VALVE ADJUSTABLE TO LOCK IN MULTIPLE POSITIONS.
- 12. POOL RECIRCULATION & INLET JETS
- a. TURNOVER RATES ACCEPTABLE, 6 HR, MAX. 300 GPM.
- b. INLET JETS ADJUSTABLE FOR DIRECTION AND FLOW. c. INLET JETS FLUSH WITH POOL WALL OR FLOOR.
- 13. CARTRIDGE FILTER. FILTERS MEET STANDARDS OF ACCEPTABILITY FOR:
- a. MAKE <u>HAYWARD</u>, MODEL <u>C7030</u>, AREA <u>700 SQ. FT</u> b. NSF LISTED
- c. FILTRATION RATE 150 GPM EACH OF TWO (2) d. BACK WASH RATE NA
- e. PRESSURE GAUGES 2 EACH, 0-100FT. PRESSURE ONE BEFORE & ONE AFTER FILTER 14. DISINFECTION.
- a. CHLORINE SYSTEM TO PROVIDED MINIMUM DISINFECTION CONCENTRATION REQUIRED, 20 PPD b. PIPING TO PROVIDED SATISFACTORY CONTRACT TIME.

GOVERNING CODES: NEW YORK DEPARTMENT OF HEALTH

BUILDING CODE OF NEW YORK 2010 PLUMBING CODE OF NEW YORK NATIONAL ELECTRICAL CODE VILLAGE OF DELHI, NEW YORK WATER & SEWER REGULATION NEW YORK STATE DEPT, OF ENVIRONMENTAL CONSERVATION **EROSION MANAGEMENT REGULATIONS** LOCAL GOVERNING UTILITIES REGULATION

EQUIPMENT & PRODUCTS NOTES

- PLUMBING FIXTURES SHALL BE COMMERCIAL MODELS AMERICAN STANDARD OF EQUAL, FLUSH VALVE
- BATHROOM FIXTURES & TOILET ACCESSORES FOR MENS & WOMENS ROOM SHALL EACH INCLUDE (BY
- a. ELECTRIC HAND DRYER, 208 VOLT, SINGLE PHASE WALL MOUNT, POWER BY E-1.
- b. MIRRORS, WALL MOUNT, MINIMUM 16" x 24".
- c. ADA APPROVED GRAB BARS, S.S. GRADE 304. d. TOILET PAPER HOLDERS, TWO(2) ROLL COMMERCIAL TYPE.
- e. TOILET & URINAL ENCLOSURES/PARTITIONS, HIGH GLOSS ENAMEL WITH LOCKABLE DOORS.
- TRUSS MOUNTED POWER VENT TO OUTSIDE LOUVER POWER BY -1.
- 3. CHLORINE & ACID METERING PUMPS TO BE PULSAFEEDER OR OTHER NATIONALLY RECOGNIZED MFR. WITH MATERIALS RECOMMENDED FOR EACH DUTY, MANUAL STROKE & SPEED ADJUSTMENT.
- POOL PUMP MODEL CHK-75, PENTAIRE OR EQUAL.
- STAINLESS STEEL GUTTER SYSTEM BY NATARE, DURATECH OR EQUAL, 5 YEARS WARRANTEE.
- MAGNETIC FLOW METER
- POOL INLET JETS POOLINE POOL JET.
- HOT BOX ALUMINUM, INSULATED & HEATED, BYHUBBELL POWER SYSTEMS.
- 9. FLOW SENSORS & MONITOR TO START/STOP METERING PUMPS, SUPPLIED BY E-1 FOR INSTALLATION BY G-1 & POWER/CONTROL BY E-1, GF SIGNET 575 PR EQUAL WALL MOUNTED 5090 FLOOR MONITOR.
- 10. MAIN POOL DRAINS 16" SQUARE STAINLESS STEEL, JOSAM 45830 WITH S.S. GRATE, 6" DRAIN CONNECTION
- 11. KADDERS INTERFAB DESIGNER 3 THREAD LADDER WITH S.S. STEPS.
- 12. MURIATIC ACID & CHLORINE TANKS 50 GALLON DOUBLE WALL # 52752 RECREONICS INC. OR EQUAL
- 13. SURGE TANK PREFAB CONCRETE LAKELANDS KISTNER OR EUQAL WITH DESIGN CERTIFICATION
- 14. HANDICAPPED LIFE TO BE INSTALLED IN LOCATION DIRECTED, BY PAL 1000 PORTABLE POOL LIFT
- 15. POOL SKIMMER 16. WOOD TRUSSES CERTIFIED BY MANUFACTORER FOR ROOF DEAD LOAD + 60 PSF LIVE LOAD + 15 PSF
- WIND LOAD. 17. HAND RAILING TO BE SEAMLESS WELDED TYPE 304 S.S.
- 18. CHECK, BALL, WAFER & GATE VALVES TO BE CLOW OR EQUAL SUBMIT FOR APPROVAL PRIOR TO
- ORDER, PVC OR S.S. WETTED PARTS. 19. RP2 SUPPLY, INSTALLATION TESTING & CERTIFICATION BY P-1, HOT BOX INSTALLED UNDER G-1 ON MINIMUM 18" COMPACTED #1/#2 CRUSHED STONE BASE, E-1 TO PROVIDE POWER



ABBREVIATION AND NOMENCLATURE

LIST OF DRAWINGS

TITLE

PROPANE TANK, CONCRETE PAD AND ENCLOSURE DETAIL

POOL EQUIPMENT PLAN, WORK AND SUPPLY SCHEDULES

SWIMMING POOL WALL & ROOF STRUCTURE SECTIONS

SWIMMING POOL PIPING PLAN - RECIRCULATION LINES

SWIMMING POOL PIPING PLAN - DRAIN (RETURN) LINES

INLET SYSTEM AND RECIRCULATION LINE CONNECTIONS

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BATH HOUSE WATER LINES, PLUMBING, FIXTURE,

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DRAWING # / PAGE #

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S-2/3

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DET-2/6

SW-1/7

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ST-3/11

ST-4/12

ST-5/13

ST-6/14

ST-7/15

SPP-1/16

SPP-1A/17

SPP-2/18

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IMPORTANT NOTE:

Refer to the Department of Health approval

certificate and/or cover letter for SPECIAL CONDITIONS regarding this approval.

CONC. = CONCRETE S.S. = STAINLESS STEEL PVC = POLYVINYL CHLORINE GPM = GALLONS PER MINUTE ST. = STEEL S.F. = SQUARE FEET W.S. = WATER SERVICE

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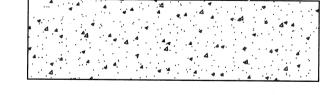
E = CENTER LINE C.O. = CLEAN OUT DRW(G) = DRAWING


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FINISH LEGEND


CONCRETE





NATURAL SOIL

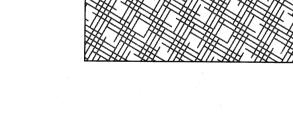CRUSHED STONE

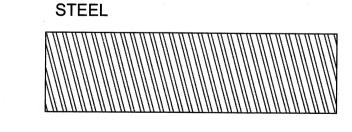

" CEMENT BACKER BOARD & DIFFERENT FOR SAND

BOARD, DOW BOARD, FOAM

SHALL BE OWENS CORNING

PSI MINIMUM, OR EQUAL

INSULATION OR AS OTHERWISE

FOAMULAR 1000 TYPE V EXTRUDED

POLYSTYRENE INSULATION 3PCF, 100



RIGID INSULATION:

Dated: August 28, 2017 ALL RIGID INSULATION, INSULATION These plans for: New Swimming CALLED OUT ON THE DRAWINGS

pools are hereby approved by tor the State Compaissioner of Health

NEW YORK STATE DEPARTMENT OF HEALTH

ONEONTA DISTRICT OFFICE

LAKESIDE ENGINEERING P.C. 1 CENTRE PARK, SUITE 305 **ROCHESTER, NY 14614** PHONE 585.279.9300 lsengrpc.com

CLIENT: TOWN OF DELHI, NEW YORK 5 ELM STREET DELHI, NEW YORK 13753

TO AFFIX HIS OR HER SEAL AND THE NOTATION "ALTERED E FOLLOWED BY HIS OR HER SIGNATURE AND A SPECIFIC

REVISIONS:

DATE DESCRIPTION

PROJECT:

TOWN OF DELHI NEW YORK MUNICIPAL SWIMMING POOL & BATH HOUSE PROJECT

DRAWING TITLE:

COVER SHEET WITH CONTENTS, GENERAL NOTES, AND ABBREVIATIONS

DRAWING NO: 06/19/17 NTS

SECTION/NO DRAWN BY: S.D./J.X. REVIEWED BY: R.P.

CS-1/0 JOB ID: DT016-001

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MUNICIPAL SWIMMING POOL & BATHHOUSE PROJECT

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LIST OF DRAWINGS

DRAWING # / PAGE #

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S-0/1

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TITLE

PROPANE TANK, CONCRETE PAD AND ENCLOSURE DETAIL

POOL EQUIPMENT PLAN, WORK AND SUPPLY SCHEDULES

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SWIMMING POOL PIPING PLAN - DRAIN (RETURN) LINES

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C.M.U. = CAST MASONRY UNIT (CONCRETE BLOCK) L.S. = LIVE LOAD D.S.= DEAD LOAD

NATURAL SOIL

SPEC@ = SPECIFICATION (SPECIFIED)

R.O.B. = RUNOFF BANK O.C.F. = OWENS CORNING FOAMULAR

REQ(D) = REQUIRED

NEC. = NECESSARY


MFR. =MANUFACTURER


C.S. = CURB STOP


ST. = STEEL

FINISH LEGEND

CONCRETE

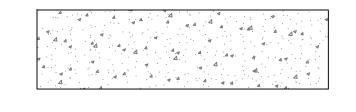

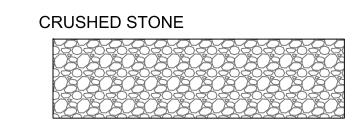

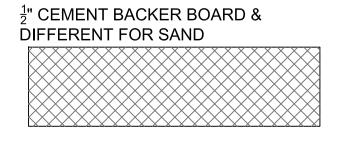

STEEL

POOL WATER

RIGID INSULATION:

ALL RIGID INSULATION, INSULATION BOARD, DOW BOARD, FOAM **INSULATION OR AS OTHERWISE** CALLED OUT ON THE DRAWINGS SHALL BE OWENS CORNING FOAMULAR 1000 TYPE V EXTRUDED POLYSTYRENE INSULATION 3PCF, 100 PSI MINIMUM, OR EQUAL

LAKESIDE ENGINEERING P.C. 1 CENTRE PARK, SUITE 305 **ROCHESTER. NY 14614** PHONE 585.279.9300

CLIENT: TOWN OF DELHI, NEW YORK **5 ELM STREET** DELHI, NEW YORK 13753

NOTICE:

O AFFIX HIS OR HER SEAL AND THE NOTATION "ALTERED BY

REVISIONS: DATE DESCRIPTION

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DRAWING NO: 06/19/17 NTS SECTION/NO DRAWN BY: S.D./J.X.

REVIEWED BY: R.P.

JOB ID: DT016-001

CS-1/0

PROJECT NOTES

- . THE CONTRACTOR SHALL LOCATE, MARK, SAFEGUARD, AND PRESERVE ALL SURVEY CONTROL MONUMENTS AND R.O.W. MONUMENTS IN THE AREA OF CONSTRUCTION. FOR DESCRIPTIVE AND SURVEY DATA ON THE CONTROL MONUMENTS, CALL THE MONROE COUNTY GEODETIC SURVEY OFFICE.
- 2. EXISTING UNDERGROUND UTILITIES SHOWN HEREON WERE PLOTTED FROM FIELD LOCATIONS AND/OR UTILITY COMPANY RECORD PLANS.
- 3. THE CONTRACTOR SHALL DETERMINE EXACT LOCATION AND ELEVATION OF UNDERGROUND UTILITIES BEFORE COMMENCING CONSTRUCTION.
- 4. CONTRACTOR SHALL MAKE EXPLORATION EXCAVATIONS TO LOCATE EXISTING UNDERGROUND FACILITIES SUFFICIENTLY AHEAD OF CONSTRUCTION TO PERMIT REVISIONS AS REQUIRED TO MEET EXISTING CONDITIONS.
- 5. SANITARY SEWER PIPE SHALL BE PVC SDR-21. WATER SERVICE SHALL BE | 1/2" COPPER PIPE.

DRAINAGE IS ACCOMPLISHED UTILIZING AN EXISTING SWALE.

- . EROSION CONTROL DEVICES TO BE ESTABLISHED PRIOR TO COMMENCING EARTHWORK. EROSION CONTROL DEVICES TO BE MAINTAINED BY THE CONTRACTOR UNTIL UPSTREAM GROUND COVER HAS BEEN ESTABLISHED AND REMOVAL IS APPROVED BY THE TOWN OF HENRIETTA
- 7. OWNER WILL BRING SWIMMING POOL & BATHHOUSE AREA TO ROUGH GRADE AT START OF WORK.

EROSION CONTROL

A. LINEAR STRAW BALES WILL BE USED ON STEEP SLOPES AND WHEREVER NECESSARY TO CONTROL EROSION AND SILTATION OF EXISTING DRAINAGE SYSTEMS AS ORDERED BY THE

B. ALL INLETS TO THE STORM SYSTEM SHALL BE STRAW BALED ON ALL SIDES TO CONTROL SILTATION. THE UTILITY CONTRACTOR SHALL BE RESPONSIBLE TO MAINTAIN THE BALES UNTIL GROUND COVER IS ESTABLISHED.

C. ALL EROSION CONTROL MEASURES TO BE IN ACCORDANCE WITH NEW YORK STATE GUIDELINES FOR URBAN EROSION AND SEDIMENT CONTROL.

D. EROSION CONTROL MEASURES SHALL BE IN PLACE AND SHALL BE APPROVED BY THE TOWN PRIOR TO ISSUANCE OF A FOUNDATION OR BUILDING PERMIT.

E. THE CONTRACTOR SHALL DESIGNATE A MEMBER OF HIS OR HER FIRM TO BE RESPONSIBLE TO MONITOR EROSION CONTROL.EROSION CONTROL MEASURES, TREE PROTECTION AND PRESERVATION THROUGHOUT CONSTRUCTION.

F. ALL DISTURBED AREAS SHALL BE PROTECTED FROM EROSION EITHER BY MULCH OR TEMPORARY SEEDING WITHIN TWO WEEKS OF DISTURBANCE.

G. ALL TREES TO BE SAVED SHALL BE PROTECTED WITH ORANGE CONSTRUCTION FENCING PLACED AT THE DRIP LINE OR A DISTANCE GREATER THAN THE DRIP LINE, TREES SHALL BE PRUNED.WATERED AND FERTILIZED PRIOR TO.DURING AND AFTER CONSTRUCTION.MATERIAL AND EQUIPMENT STORAGE SHALL NOT BE ALLOWED IN FENCED AREAS.

H. ANY CONTRACTOR OR INDIVIDUAL INVOLVED IN THE PLANTING.MAINTENANCE OR REMOVAL OF TREES SHALL COMPLY WITH THE REQUIREMENTS OF THE TOWN'S REMOVAL OF TREES SHALL COMPLY WITH THE REQUIREMENTS OF THE TOWN'S COMPREHENSIVE DEVELOPMENT REGULATIONS FOR EXCAVATION AND CLEARING (CHAPTER GG), TREES (CHAPTER 175) AND OTHER PERTINENT REGULATION. THE CONTRACTOR SHALL BE A REGISTERED TREES SERVICE PROVIDER WITH THE TOWN, SHALL CARRY INSURANCE AS REQUIRED BY CHAPTER 175 OF THE TOWN'S COMPREHENSIVE DEVELOPMENT REGULATION.


SITE PLAN OF SITE SCALE 1" =20'



ENGINEERING P.C. 1 CENTRE PARK, SUITE 305

ROCHESTER, NY 14614 PHONE 585.279.9300 lsengrpc.com

CLIENT: TOWN OF DELHI, NEW YORK 5 ELM STREET DELHI, NEW YORK 13753

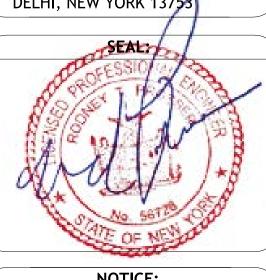

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| REVISIONS: | | | |
|------------|------|-------------|--|
| NO. | DATE | DESCRIPTION | |
| 1. | | | |
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| | | | |

PROJECT:

TOWN OF DELHI, NEW YORK MUNICIPAL SWIMMING POOL & BATH HOUSE PROJECT

DRAWING TITLE:


OVERALL GENERAL SITE PLAN, FOR INFORMATION ONLY

DATE: 03/22/17

SCALE: 1" =20' DRAWN BY: J.L.M. + S.D. REVIEWED BY: R.P.

SECTION NO. / SHEET NO.

S-0 /1

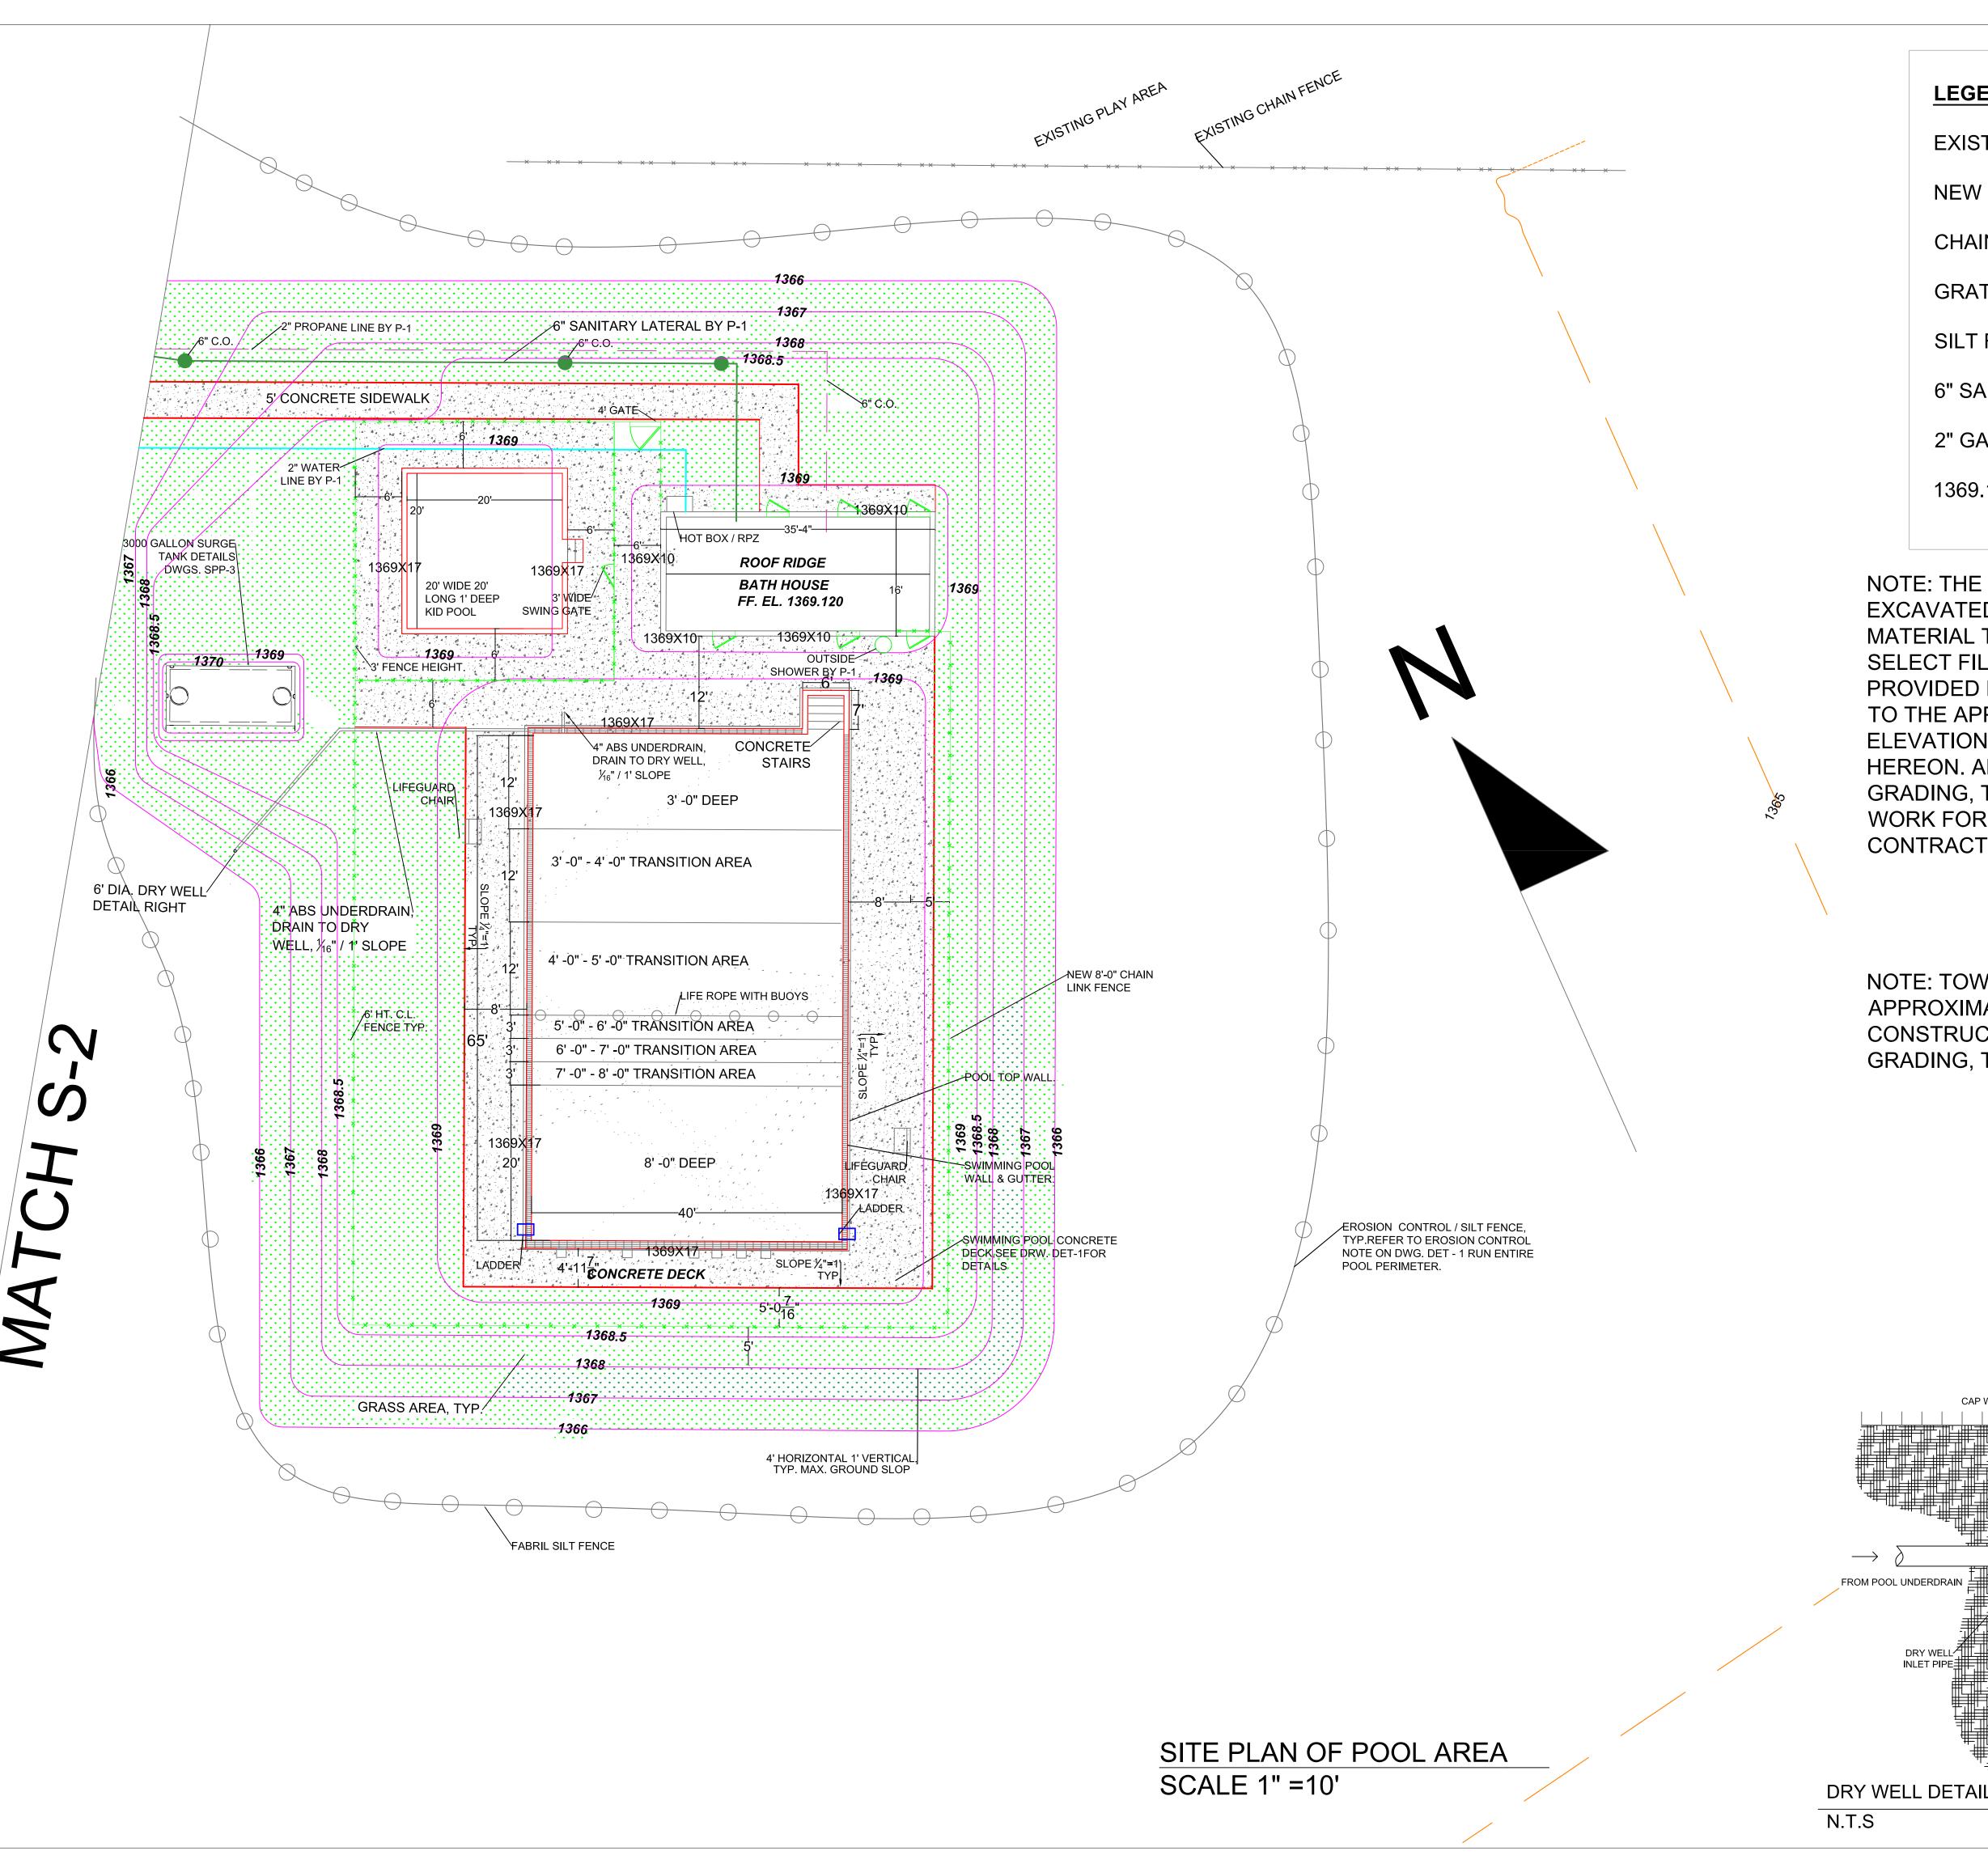

NOTE: THE EXISTING SITE WILL BE EXCAVATED OF DEMOLITION & DEBRIS MATERIAL TO AN APPROX. 8'0 DEPTH. CLEAN SELECT FILL MATERIALS WILL THEN BE PROVIDED BY OTHERS, FULLY COMPACTED, TO THE APPROXIMATE POOL BOTTOM ELEVATIONS SHOWN MINUS ONE FT. (+/-), HEREON. ALL EROSION MANAGEMENT, GRADING, TOP SOIL, SEEDING, & OTHER WORK FOR FINAL COMPLETION SHALL BE BY CONTRACT G-1

NOTE: TOWN WILL FILL SITE TO
APPROXIMATES GRADES REQUIRED FOR
CONSTRUCTION, CONTRACTOR DOES FINAL
GRADING, TOPSOIL, SEED, ETC.

4" TOPSOIL + SEED

TILTER FABRIC LINES
TOP. BOTTOM. AND
SIDES OF DRY WELL

SEAL:

CLIENT:

TOWN OF DELHI, NEW YORK

5 ELM STREET

LAKESIDE

ENGINEERING P.C.

1 CENTRE PARK, SUITE 305 ROCHESTER, NY 14614

PHONE 585.279.9300

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REVISIONS:

NO. DATE DESCRIPTION

1. 7/31/17 REVISE WADING POOL SIZE 20' x 20'

PROJECT:

TOWN OF DELHI, NEW YORK MUNICIPAL SWIMMING POOL & BATH HOUSE PROJECT

DRAWING TITLE:

SITE PLAN OF POOL AREA & DRY WELL DETAIL

DATE: 08/07/17

SCALE: AS SHOWN

DRAWN BY: S.D./J.X

REVIEWED BY: R.P.

JOB ID: DT016-001


SECTION NO./
SHEET NO.

S-1/2

LEGEND OLD CONTOUR **NEW CONTOUR** CHAIN LINK FENCE \times \times \times \times CONTRACT LIMIT FOR G-1 VILLAGE SANITARY SEWER & MANHOLE **NEW 6" SANITARY** SEWER LINE (P-1) 2" GAS LINE (P-1) 2" WS 2" WS LINE (P-1)

NOTE: G-1 CONTRACT INCLUDES SIDEWALK, PROPANE TANK WORK, (PORTABLE TANK BY OTHERS) SIDEWALK, ASPHALT, HANDICAPPED PARKING, & NECESSARY LANDSCAPING ONLY TO CONTRACT LIMIT LINE SHOWN. P-1 TO PROVIDE WATER LINE SEWER LINE & PROPANE LINE WORK


SITE PLAN OF PARKING AREA SCALE 1" =10'

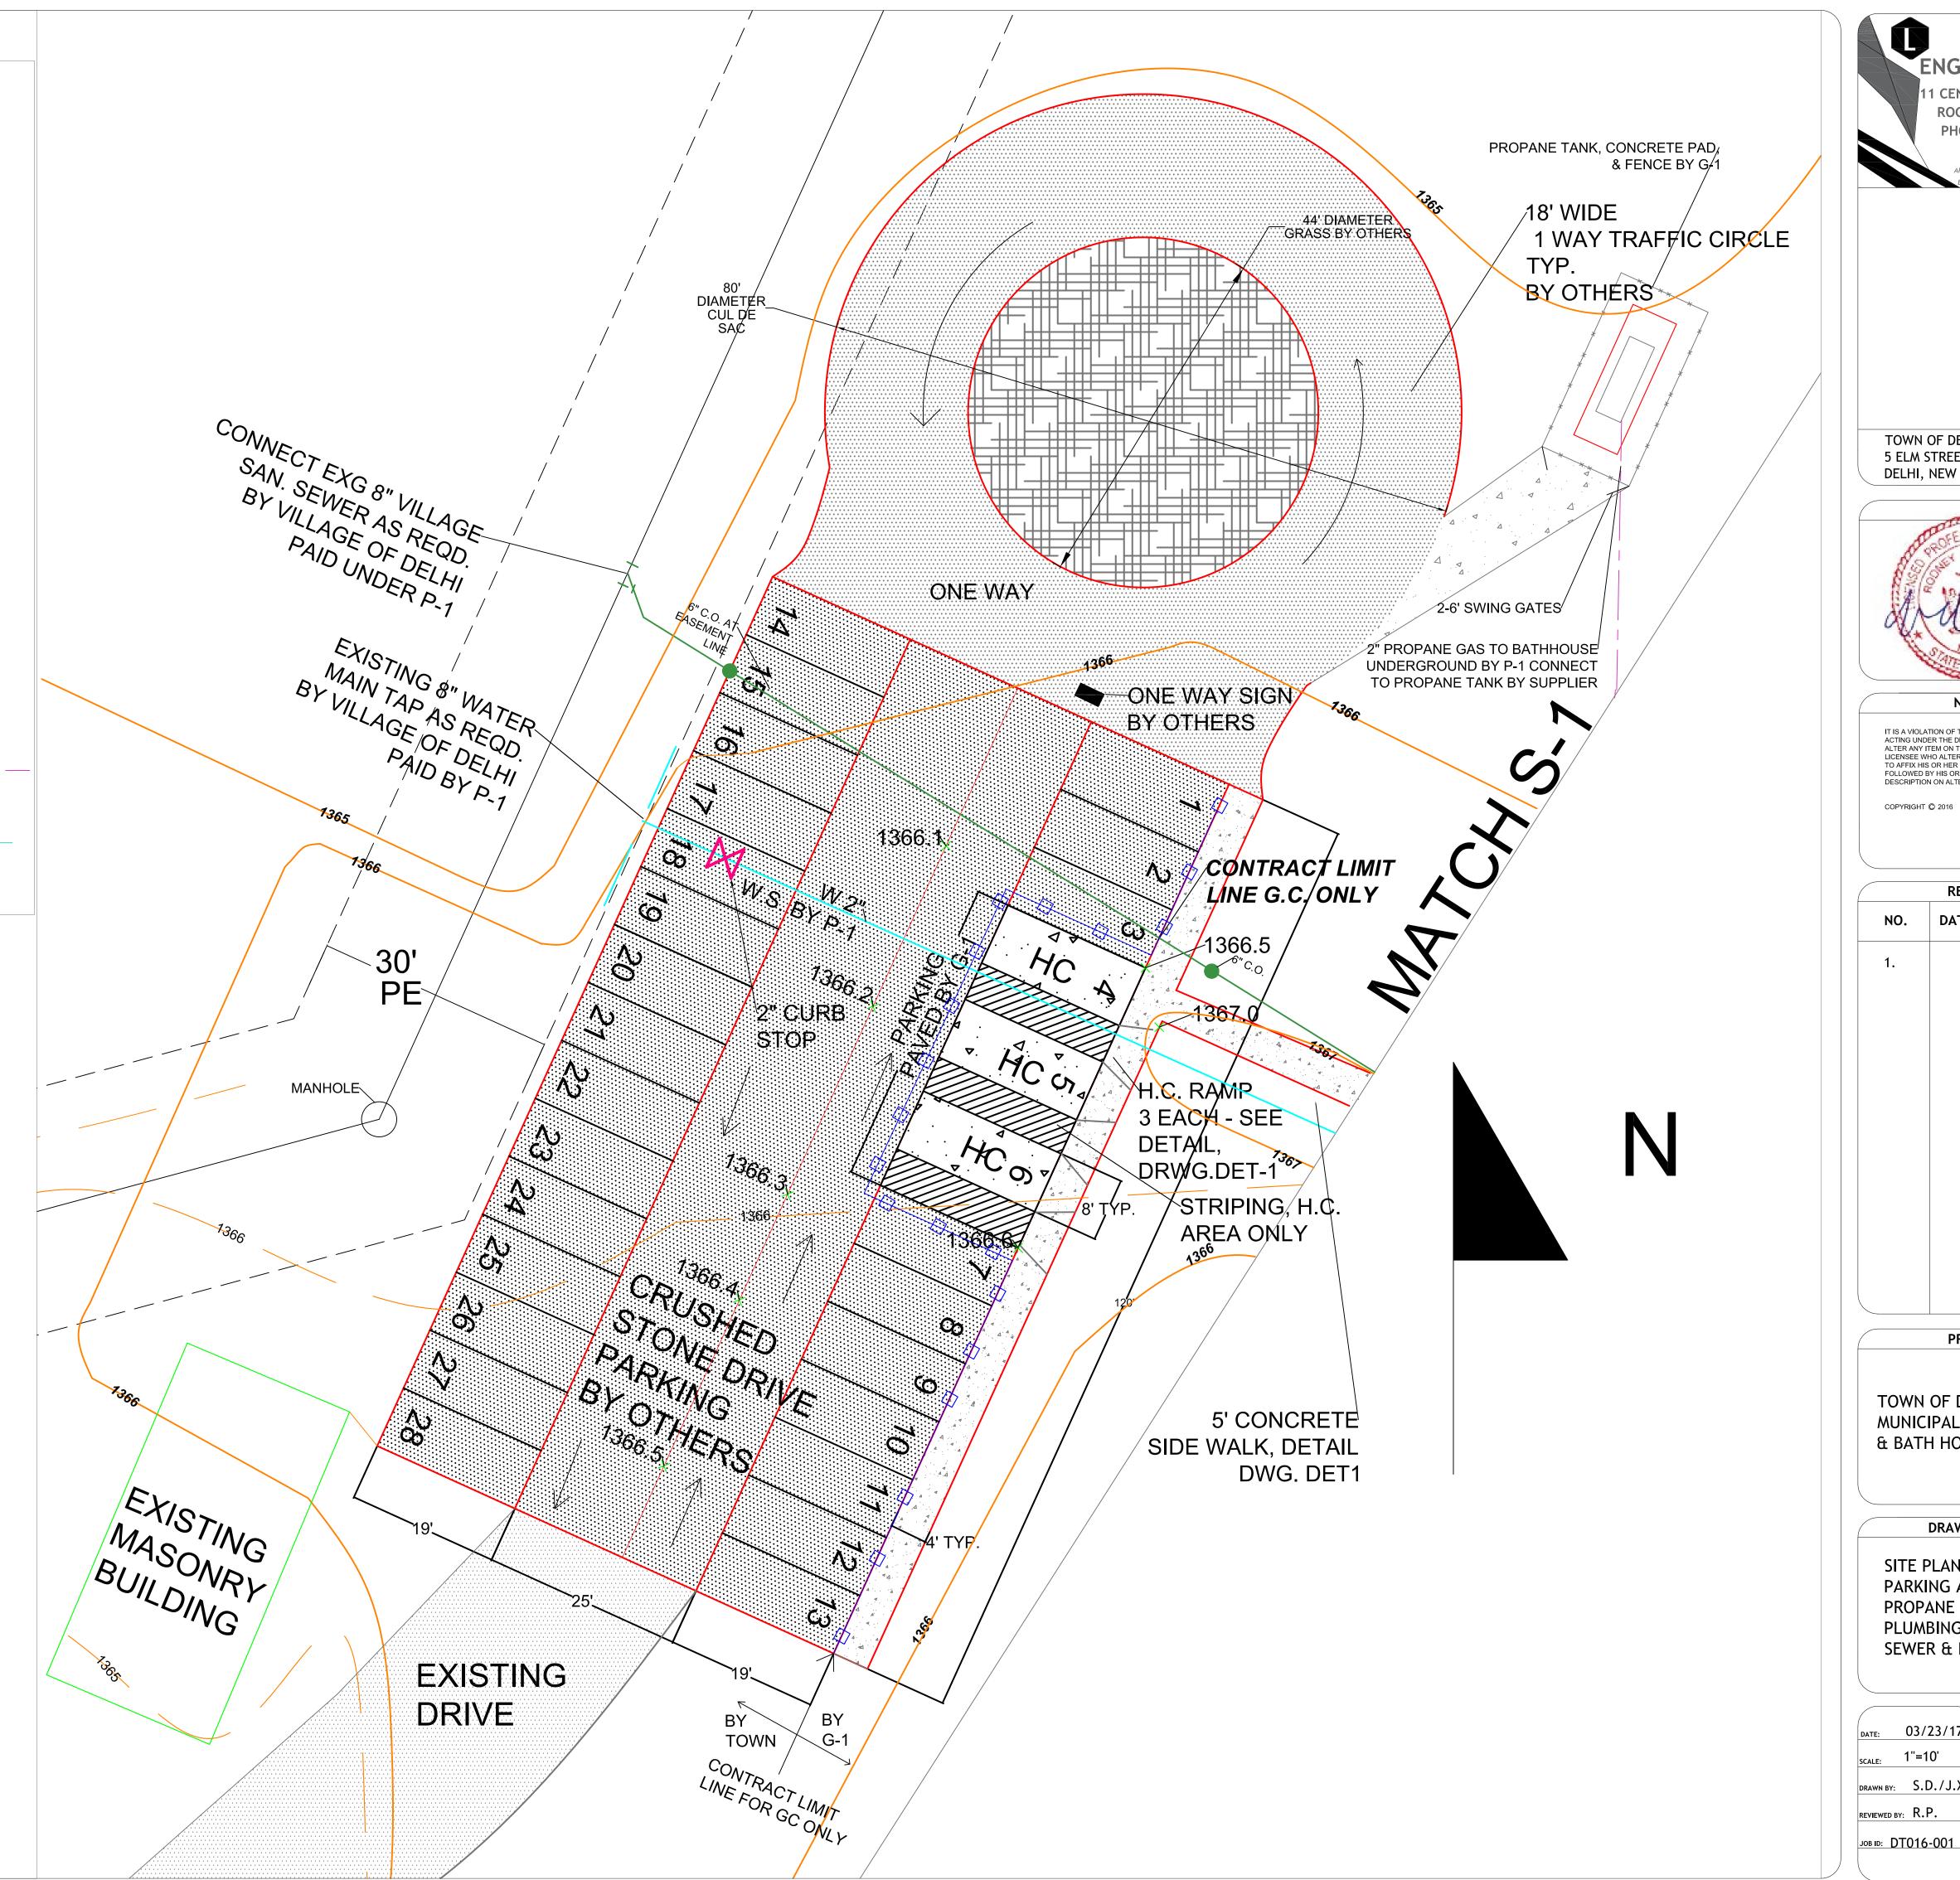

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CLIENT:

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REVISIONS: DATE DESCRIPTION

PROJECT:

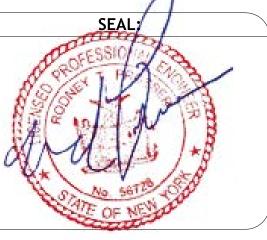
TOWN OF DELHI NEW YORK MUNICIPAL SWIMMING POOL & BATH HOUSE PROJECT

DRAWING TITLE:

SITE PLAN OF DRIVEWAY & PARKING AREA & LIQUID PROPANE STORAGE TANK, PLUMBING P-1 WATER, SEWER & PROPANE

03/23/17 DRAWN BY: S.D./J.X.


SECTION NO./ SHEET NO. S-2/3

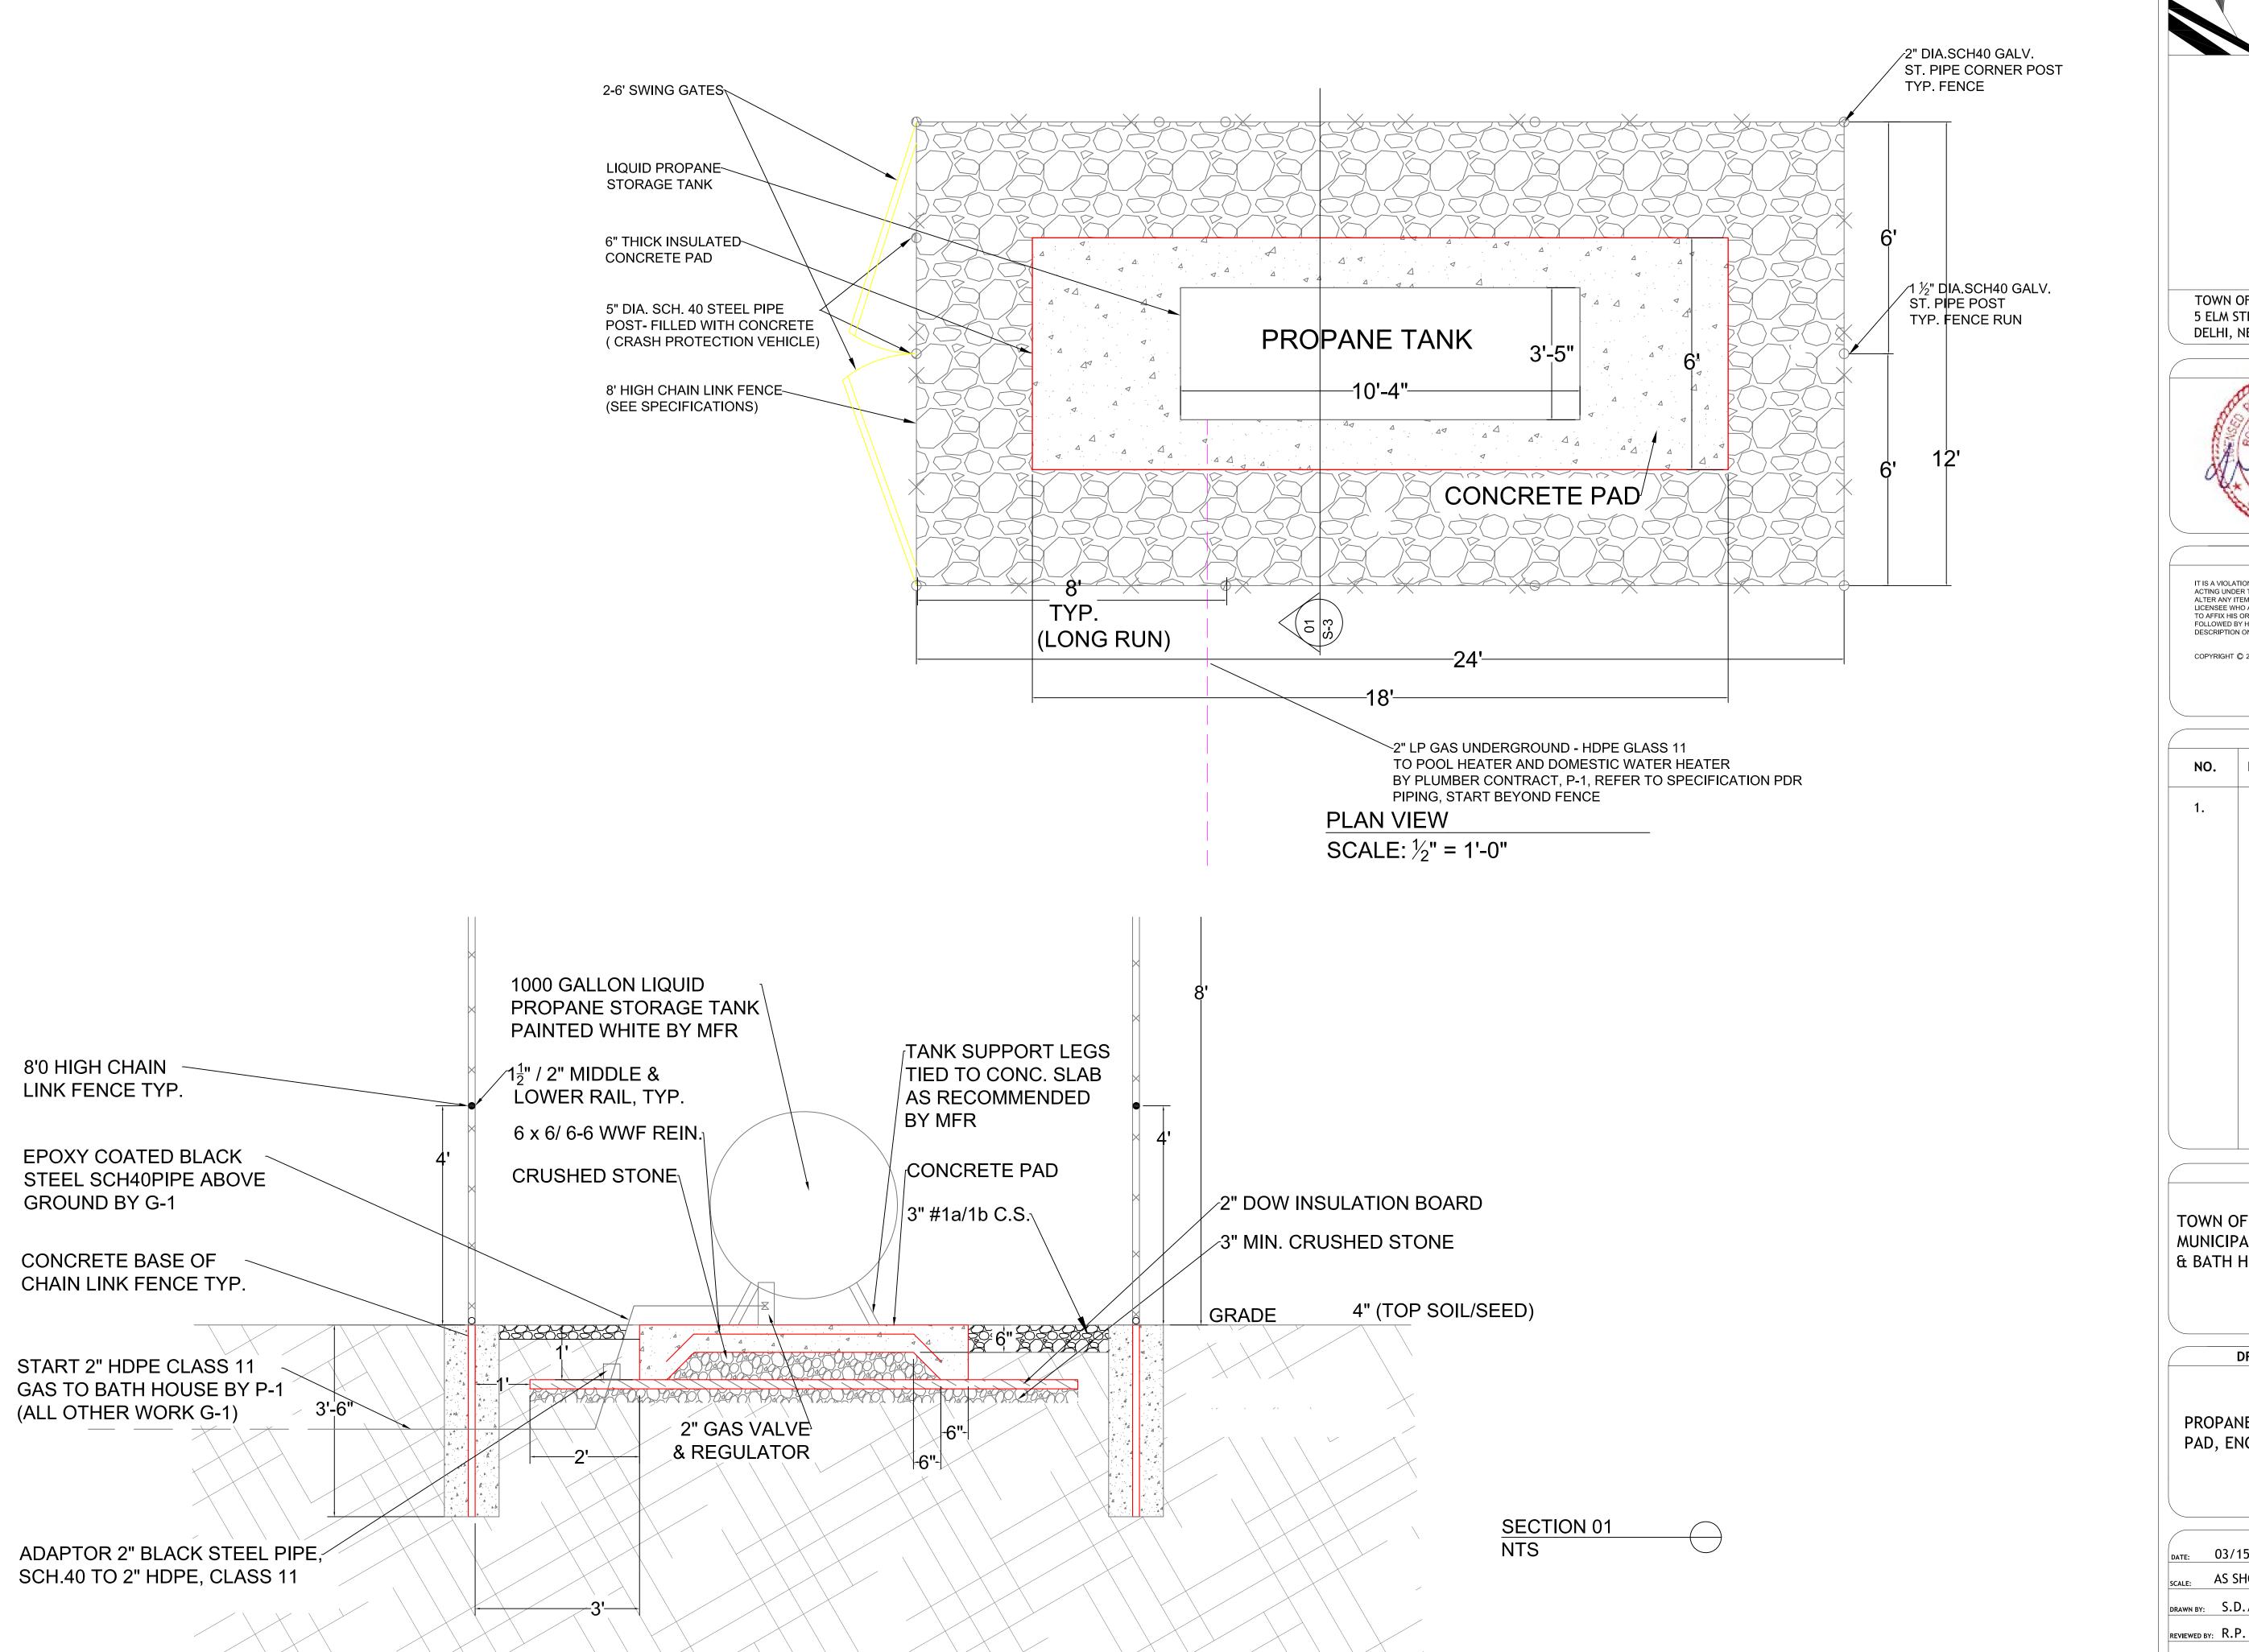

LAKESIDE ENGINEERING P.C. 1 CENTRE PARK, SUITE 305 ROCHESTER, NY 14614 PHONE 585.279.9300 lsengrpc.com CTRICAL & MECHANICAL ENGINEERS

CLIENT:

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REVISIONS:

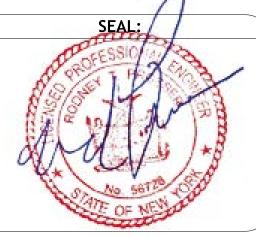DATE DESCRIPTION

PROJECT:

TOWN OF DELHI NEW YORK MUNICIPAL SWIMMING POOL & BATH HOUSE PROJECT

DRAWING TITLE:


PROPANE TANK, CONCRETE PAD, ENCLOSURE


03/15/17 AS SHOWN DRAWN BY: S.D./J.X.

SECTION NO. / SHEET NO.


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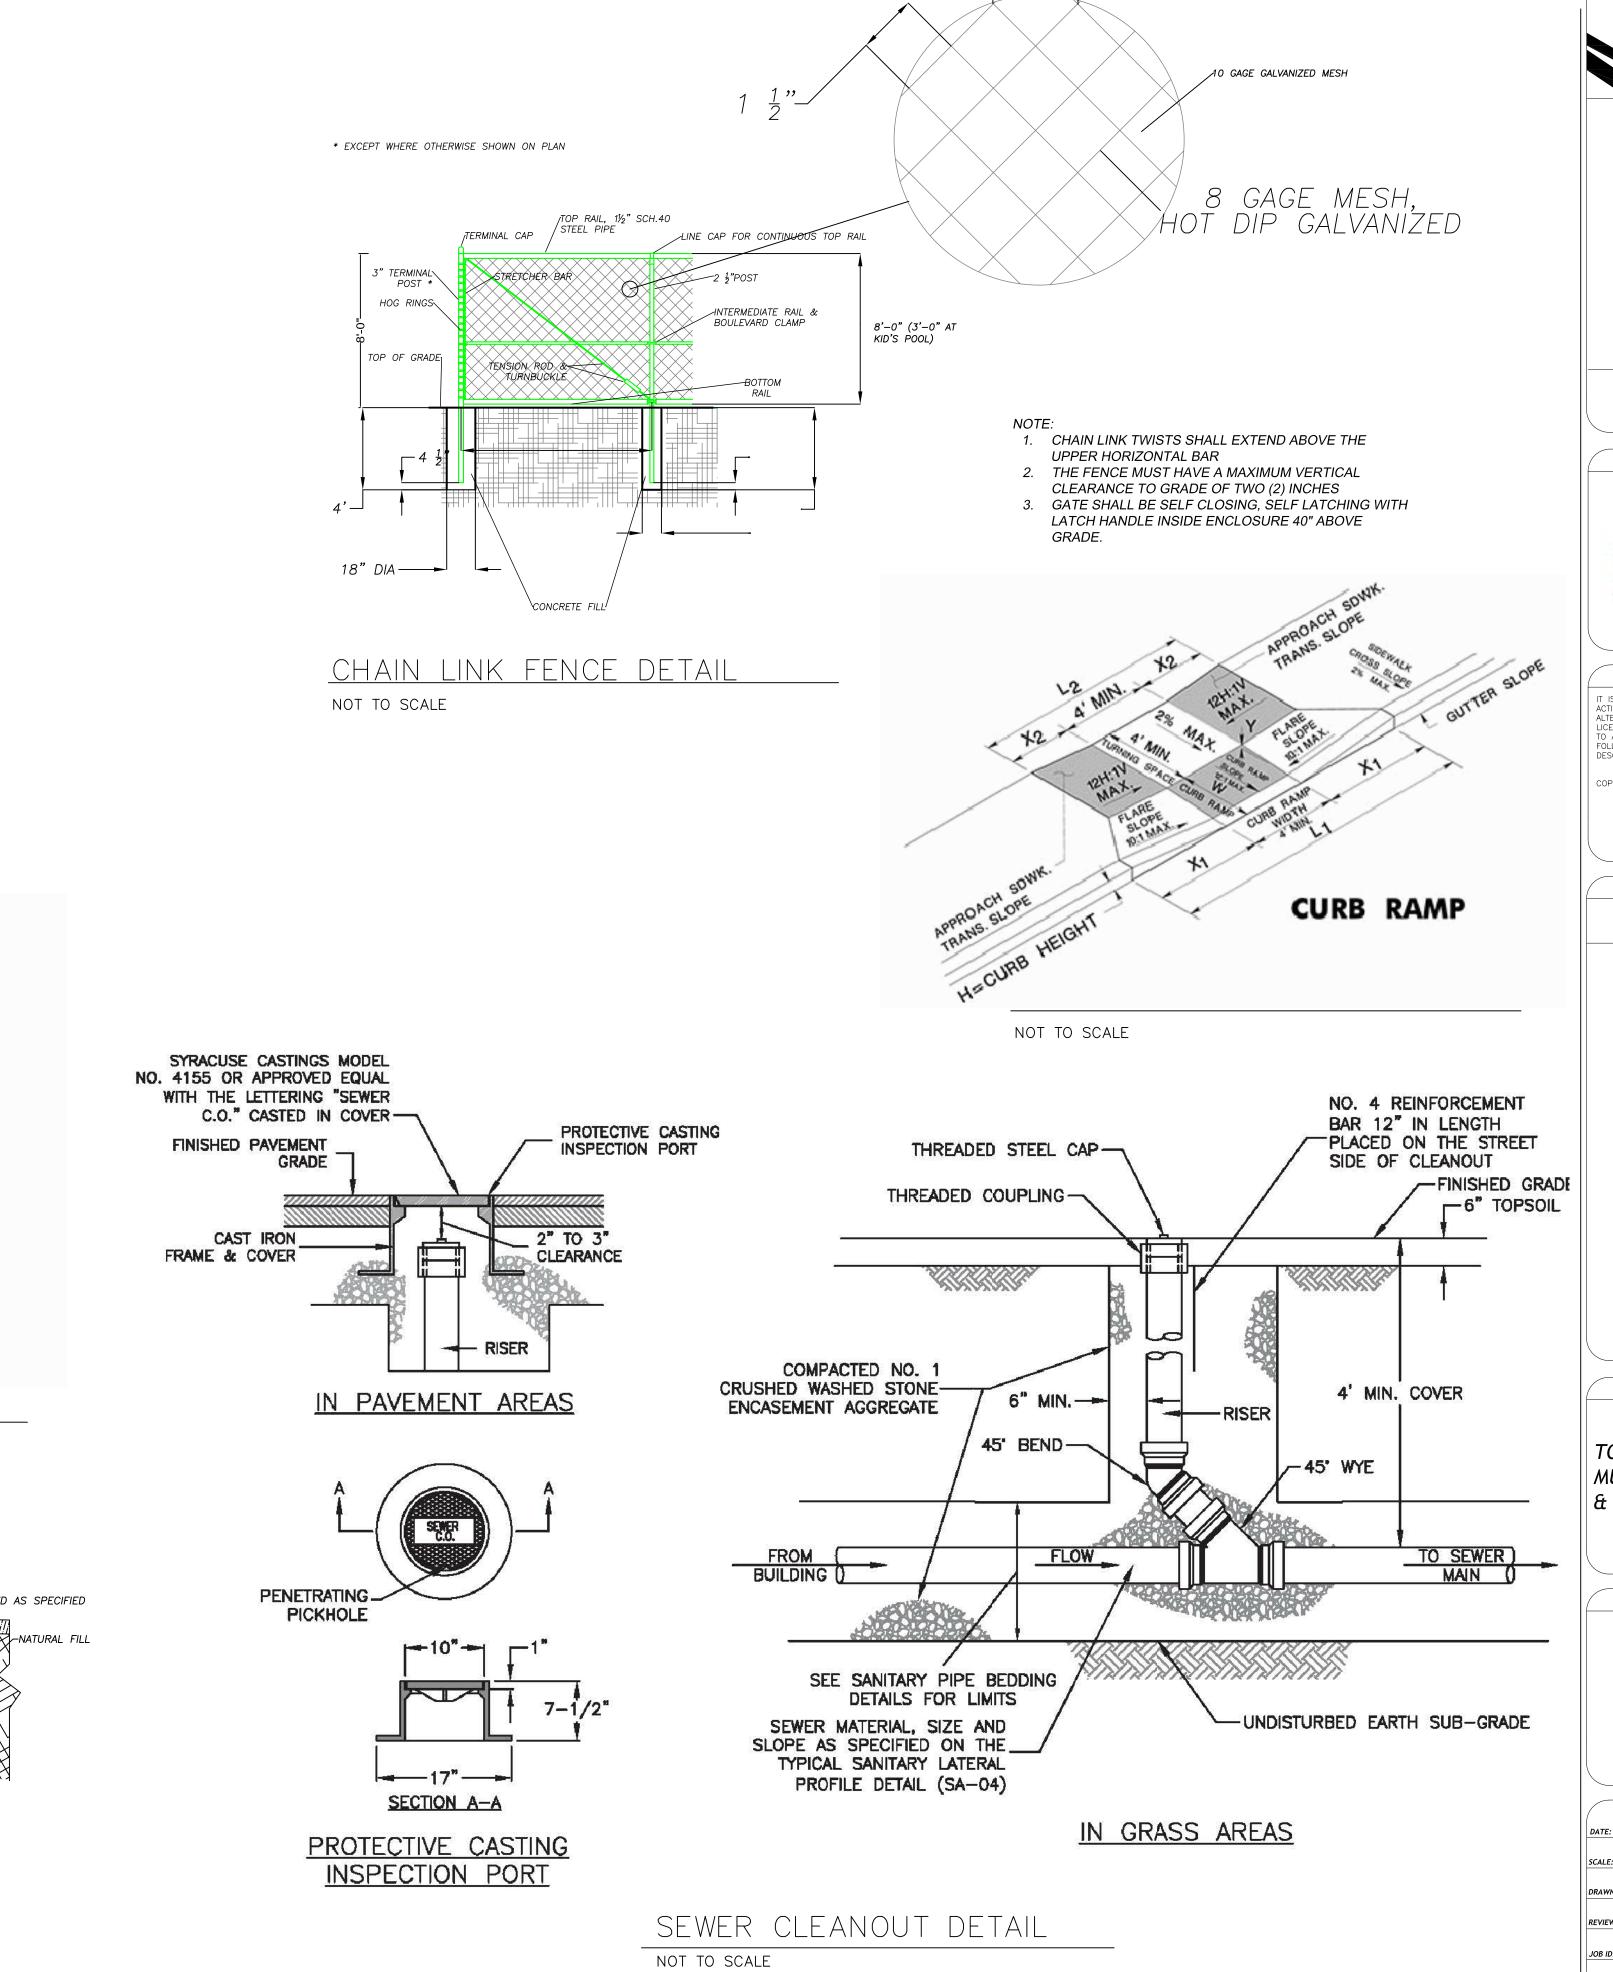
S-3/4 _{ЈОВ ID:} DT016-001




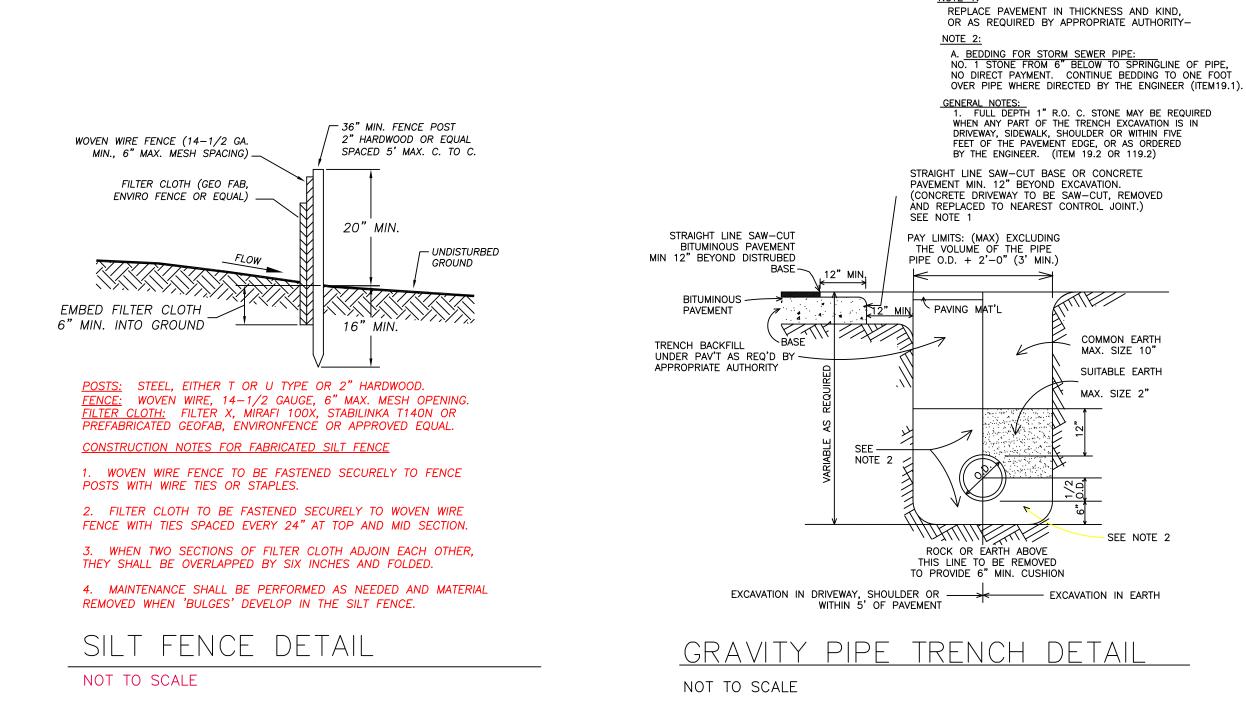

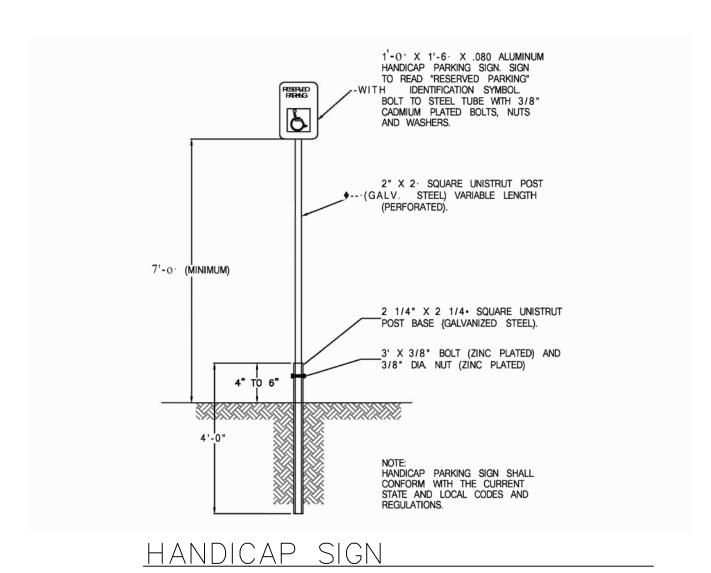
SEE NOTE 2



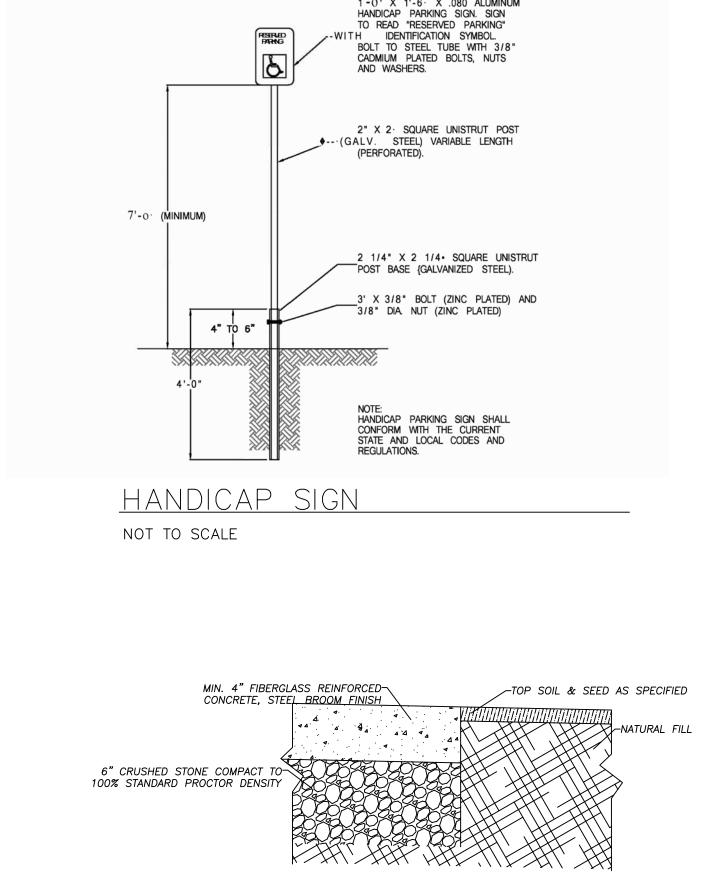

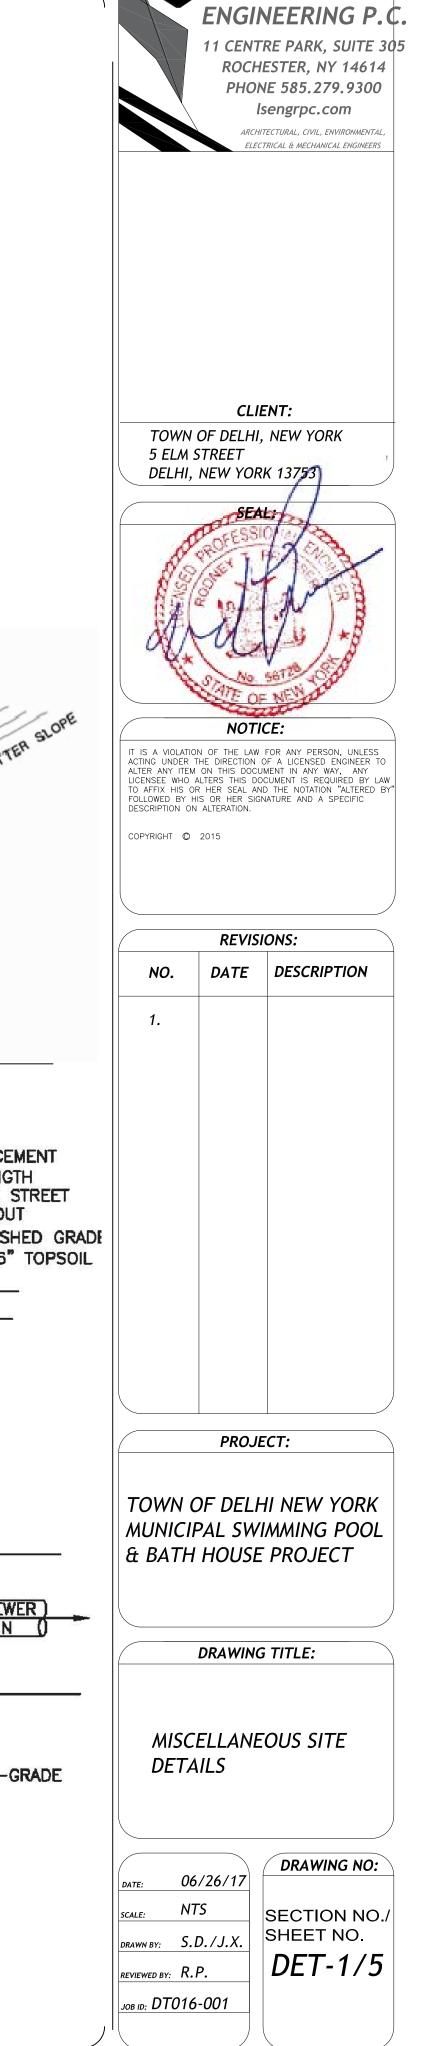

LAKESIDE

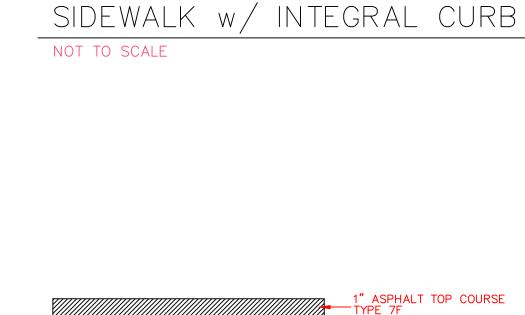

- x - x - x

6" CONCRETE SIDEWALK

4000 psi, BROOM FINISHED -6x6-6x6 WWF


12" MIN #1 & #2 CRUSHED STONE

COMPACTED SUBSOIL -


— 1/4" EXPANSION JOINT

6"x18" CONCRETE CURB

6" REVEAL, 3000 psi

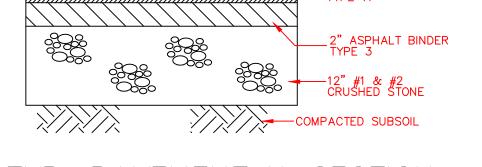

TYP. PAVEMENT X-SECTION NOT TO SCALE

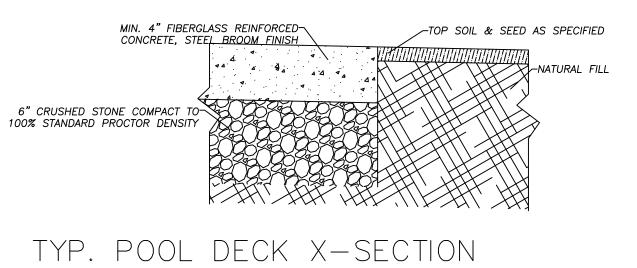

NOT TO SCALE

PROJECT NOTES

- I. ALL IMPROVEMENTS SHALL BE IN ACCORDANCE WITH THE MOST RECENT STANDARDS AND SPECIFICATIONS OF THE TOWN OF DELHI, AND/OR THE APPROPRIATE WATER AND/OR SEWER AND/OR DRAINAGE DISTRICT(S), UNLESS OTHERWISE NOTED.
- 2. THE CONTRACTOR SHALL LOCATE, MARK, SAFEGUARD, AND PRESERVE ALL SURVEY CONTROL MONUMENTS AND R.O.W. MONUMENTS IN THE AREA OF CONSTRUCTION. FOR DESCRIPTIVE AND SURVEY DATA ON THE CONTROL MONUMENTS, CALL THE MONROE COUNTY GEODETIC SURVEY OFFICE.
- 3. EXISTING UNDERGROUND UTILITIES SHOWN HEREON WERE PLOTTED FROM FIELD LOCATIONS AND/OR UTILITY COMPANY RECORD PLANS.
- 4. THE CONTRACTOR SHALL DETERMINE EXACT LOCATION AND ELEVATION OF UNDERGROUND UTILITIES BEFORE COMMENCING CONSTRUCTION.
- 5. CONTRACTOR SHALL MAKE EXPLORATION EXCAVATIONS TO LOCATE EXISTING UNDERGROUND FACILITIES SUFFICIENTLY AHEAD OF CONSTRUCTION TO PERMIT REVISIONS AS REQUIRED TO MEET EXISTING CONDITIONS.
- 6. SANITARY SEWER PIPE SHALL BE PVC SDR-21.
 WATER SERVICE SHALL BE 2" COPPER PIPE.
 DRAINAGE IS ACCOMPLISHED UTILIZING AN EXISTING SWALE.
- 7. EROSION CONTROL DEVICES TO BE ESTABLISHED PRIOR TO COMMENCING
 EARTHWORK. EROSION CONTROL DEVICES TO BE MAINTAINED BY THE CONTRACTOR
 UNTIL UPSTREAM GROUND COVER HAS BEEN ESTABLISHED AND REMOVAL IS
 APPROVED BY THE TOWN OF DELHI
- 8. ALL ROOF DRAINS SHALL BE CARRIED BY DOWN SPOUTS TO SPLASH BLOCKS.
- 9. UPON COMPLETION OF THE PROJECT, AS BUILT PLANS OF THE COMPLETED SITE WORK, BUILDING LOCATION, AND LANDSCAPING SHALL BE FURNISHED ON BY THE OWNER PRIOR TO THE ISSUANCE OF THE CERTIFICATE OF OCCUPANCY, SUCH PLANS SHALL BE FILED WITH THE TOWN BUILDING DEPARTMENT.
- I O. PINNING OF LOT CORNERS SHALL BE COMPLETED BEFORE THE ISSUANCE OF THE CERTIFICATE OF OCCUPANCY.
- I I. IT SHALL BE THE RESPONSIBILITY OF THE CONTRACTOR TO IMPLEMENT SUITABLE DUST CONTROL MEASURES ON ALL GRAVEL OR STONE PARKING AREAS & ROADWAY SURFACES TO SATISFY TOWN REQUIREMENTS.
- I 2. IT IS THE RESPONSIBILITY OF THE CONTRACTOR TO ENSURE THAT ADEQUATE EROSION CONTROL MEASURES ARE INSTALLED TO PREVENT THE MIGRATION OF SOILS FROM THIS SITE.

EROSION CONTROL

A. LINEAR STRAW BALES WILL BE USED ON STEEP SLOPES AND WHEREVER NECESSARY TO CONTROL EROSION AND SILTATION OF EXISTING DRAINAGE SYSTEMS AS ORDERED BY THE ENGINEER.

B. ALL INLETS TO THE STORM SYSTEM SHALL BE STRAW BALED ON ALL SIDES TO CONTROL SILTATION. THE UTILITY CONTRACTOR SHALL BE RESPONSIBLE TO MAINTAIN THE BALES UNTIL GROUND COVER IS ESTABLISHED.


C. ALL EROSION CONTROL MEASURES TO BE IN ACCORDANCE WITH NEW YORK STATE GUIDELINES FOR URBAN EROSION AND SEDIMENT CONTROL.

D. EROSION CONTROL MEASURES SHALL BE IN PLACE AND SHALL BE APPROVED BY THE TOWN PRIOR TO ISSUANCE OF A FOUNDATION OR BUILDING PERMIT.

E. THE CONTRACTOR SHALL DESIGNATE A MEMBER OF HIS OR HER FIRM TO BE RESPONSIBLE TO MONITOR EROSION CONTROL. EROSION CONTROL MEASURES, TREE PROTECTION AND PRESERVATION THROUGHOUT CONSTRUCTION.

F. ALL DISTURBED AREAS SHALL BE PROTECTED FROM EROSION EITHER BY MULCH OR TEMPORARY SEEDING WITHIN TWO WEEKS OF DISTURBANCE.

G. ALL TREES TO BE SAVED SHALL BE PROTECTED WITH ORANGE CONSTRUCTION FENCING PLACED AT THE DRIP LINE OR A DISTANCE GREATER THAN THE DRIP LINE, TREES SHALL BE PRUNED.WATERED AND FERTILIZED PRIOR TO.DURING AND AFTER CONSTRUCTION.MATERIAL AND EQUIPMENT STORAGE SHALL NOT BE ALLOWED IN FENCED AREAS.

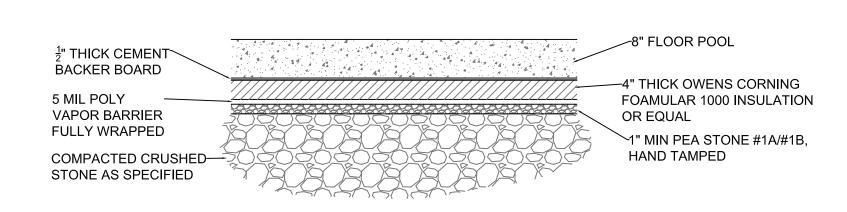

POOL FLOOR FOAM BOARD INSULATION TREATMENT DETAIL N.T.S.

GRADING

I. ALL SITE ROUGH GRADING SHALL BE COMPLETED BEFORE NEW CONSTRUCTION CAN PROCEED.

EROSION AND SEDIMENT CONTROL/CONSTRUCTION SEQUENCE

PRIOR TO STARTING CONSTRUCTION AND DISTURBING THE SITE, THE GENERAL CONTRACTOR WILL BE RESPONSIBLE FOR ESTABLISHING THE TEMPORARY STABILIZED CONSTRUCTION ENTRANCE IN THE LOCATION OF THE PROPOSED ENTRANCE & ESTABLISHING THE PERIMETER SILTATION FENCING. ONCE THESE MEASURES ARE IN PLACE, THE GENERAL CONTRACTOR CAN THEN PERFORM NECESSARY CLEARING AND CONSTRUCTION ON THE SITE. STOCKPILED TOPSOIL IS TO BE STORED AT THE REAR AND PROTECTED BY ITS OWN STOCKPILE PERIMETER SILTATION FENCE. EXCESS SPOIL IS TO BE IMMEDIATELY REMOVED FROM THE SITE.


WHENEVER ACTIVITIES TEMPORARILY CEASE DURING CONSTRUCTION, SOIL STOCKPILES AND EXPOSED SOIL SHOULD BE STABILIZED BY SEED, MULCH OR OTHER APPROPRIATE MEASURES AS SOON AS POSSIBLE, BUT IN NO CASE MORE THAN 14 DAYS AFTER CONSTRUCTION ACTIVITIES HAVE CEASED. FOLLOWING INITIAL SOIL DISTURBANCE OR RE-DISTURBANCE, PERMANENT OR TEMPORARY, STABILIZATION SHOULD BE COMPLETED WITHIN 14 DAYS OR AS SOON AS POSSIBLE. TEMPORARY OR PERMANENT STABILIZATION MEASURES SHALL BE APPLIED IMMEDIATELY ON ALL DISTURBED AREAS WHERE WORK IS DELAYED OR COMPLETED. DURING CONSTRUCTION ACTIVITIES, THE GENERAL CONTRACTOR IS RESPONSIBLE FOR MAINTAINING AND INSPECTING EROSION AND SEDIMENT CONTROL MEASURES ON A DAILY BASIS. ROUTINE MAINTENANCE MUST BE IDENTIFIED ON THE CONSTRUCTION SCHEDULE AND PERFORMED ON A REGULAR BASIS AND AS SOON AS PROBLEM IS IDENTIFIED. DURING CONSTRUCTION ACTIVITIES, THE GENERAL CONTRACTOR WILL BE RESPONSIBLE FOR CONDUCTING ANY MAINTENANCE. THIS PERIOD SHALL INCLUDE ALL THE REQUIRED SITE AND BUILDING CONSTRUCTION IMPROVEMENTS. NO SEDIMENTATION CONTROL DEVICE MAY BE REMOVED WITHOUT APPROVAL OF THE TOWN. WHEN GROUND COVER IS FULLY ESTABLISHED AND CONSTRUCTION IS DEEMED COMPLETE, THEN MAY EROSION CONTROL DEVICES AND CONSTRUCTION FENCING BE REMOVED. PRIOR TO REMOVAL OF EROSION MANAGEMENT SYSTEM, TOPSOIL, SEEDING AND DEVELOPMENT OF GRASSED AREAS IS REQUIRED TO THE SATISFACTION OF THE TOWN.

IN ORDER TO FINALIZE GRADING AND LANDSCAPING, ALL OPEN AREAS INCLUDING BORROW AND SPOIL AREAS MUST BE STABILIZED. STABILIZATION MUST BE UNDERTAKEN NO LATER THAN 14 DAYS AFTER CONSTRUCTION ACTIVITIES HAVE CEASED. NO TEMPORARY EROSION AND SEDIMENT CONTROL MEASURES MAY BE REMOVED WITHOUT APPROVAL FROM THE TOWN OFFICIALS.

ALL ELEVATIONS USGS DATUM, 1988

5 MIL POLY VAPOR BARRIER FULLY TAPED & ADHERED TO INSULATION BOARD CRUSHED STONE OR OTHER SPECIFIED BACKFILL POOL CONCRETE SIDE WALL 4" FOAMULAR INSULATION FULLY ADHERED TO WALL AND MECHANICALLY FASTENEND WITH TAPCONS 2' C.C.

POOL SIDEWALL FOAM BOARD INSULATION DETAIL N.T.S.

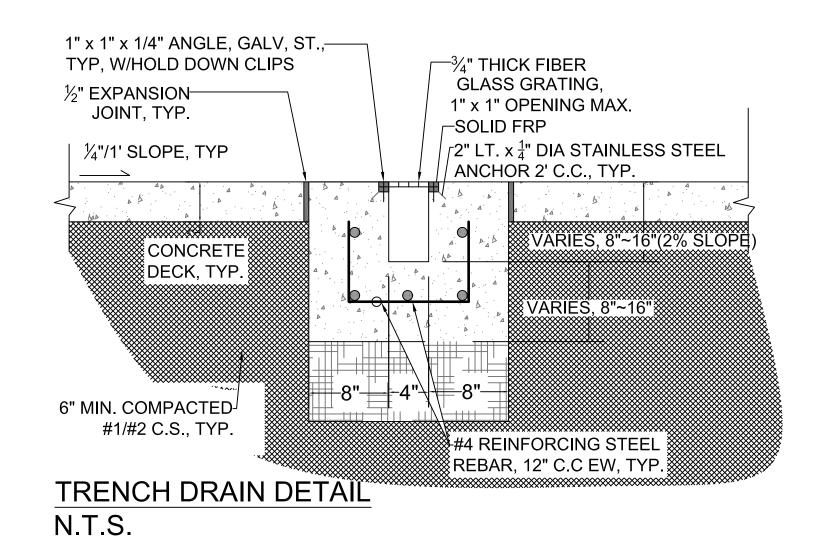

PUBLIC WATER SERVICE LINE NOTES

USE THESE NOTES FOR WATER SERVICE SIZED 1", 1-1/2, 2" ONLY. SERVICE CONNECTIONS ARE TO BE TAPPED OFF AND EXISTING WATER MAIN.


- 1. Water service lines (laterals) shall be constructed in acordance with the regulations and specifications of the Village of Delhi.
- 2. Water service lines shall have minimum of five feet of cover from finished grade in lawn areas and six feet of cover from finished grade in paved areas.
- 3. Water service lines shall be separated at least ten feet, measured from the outside of pipes, from sewer mains or septic systems.
- 4. Water service line shall be identified as:

| DESCRIPTION | SIZE ^(a) | MATERIAL ^(b) | TYPE ^(c) |
|--|---------------------|--|---------------------|
| VILLAGE Portion = from the water main to and including the control valve on the ROW/property/easement line | 2" | Type "K" Copper | О |
| Private portion= from the control valve to the meter | | PE, #3408, SDR 9, ASTM 2737, NSF-PW, 200 PSI | D |

(a) Minimum size is 1- inch.

(b) Acceptable material for private portion is either Type "K" Copper or polyethylene plastic, PE, #3408, SDR 9, ASTM 2737, NSF-PW, 200 PSI (C) Service Type include: Domestic = DS, Fire = FS. or combined = CMB

- Water meter(s) to be located on the interior of exterior wall(s) immediately upon service entrance into the building(s). When service length exceeds 500 ft or installed adjacent to /through wetlands, marshy areas, or ponds a meter tile (for $\frac{5}{8}$ " or 1" meters) or meter pit (for > than 1" meter) is required.
- 6. The private portion of the service line must be installed prior to the installations of the village portion of the service line.
- 7. All private water service to be installed in compacted select dry earth or sand.

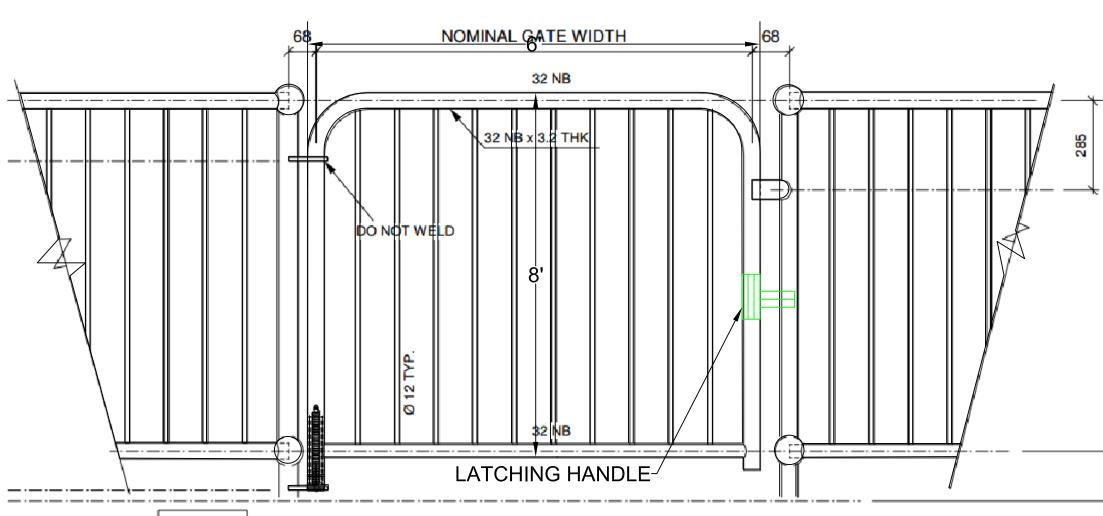


SELF-CLOSING GATE N.T.S.

NOTE: THE LATCH HANDLE LOCATED WITHIN THE ENCLOSURE AND AT LEAST 40 INCHES ABOVE GRADE

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CLIENT:
TOWN OF DELHI, NEW YORK
5 ELM STREET
DELHI, NEW YORK 13753

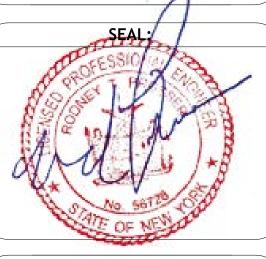

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NO. DATE DESCRIPTION

1. 6/16/2017 ADD SELF-CLOSING GATE DETAIL & NOTE

PROJECT:

TOWN OF DELHI, NEW YORK MUNICIPAL SWIMMING POOL & BATH HOUSE PROJECT

DRAWING TITLE:

PROJECT GRADING, EROSION CONTROL NOTES, WATER SERVICE NOTES & INSULATION DETAILS POOL, TRENCH DRAIN DETAIL, SELF CLOSING GATE & DETAIL

DRAWING NO:

DRAWING NO:


SCALE: N.T.S.

DRAWING NO:

SECTION NO./
SHEET NO.


REVIEWED BY: R.P.

DET-2/6

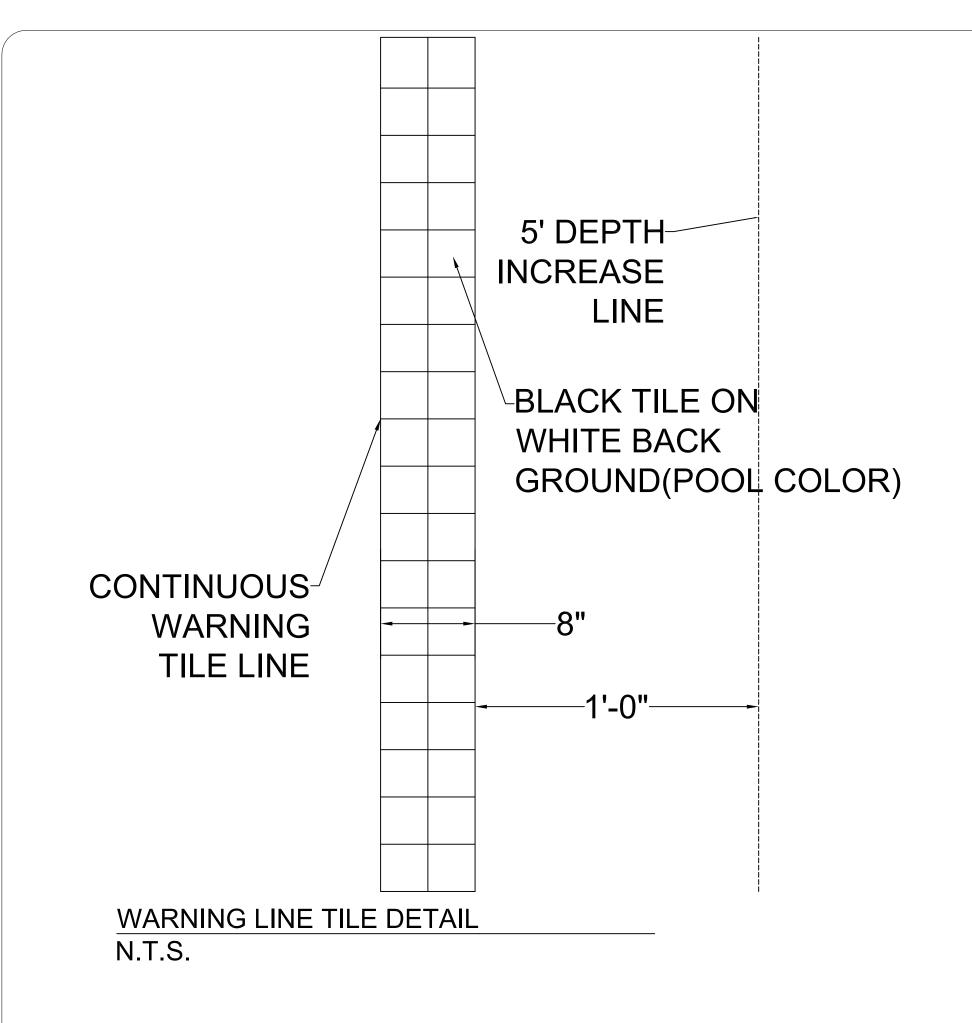


| SAFETY EQUIPMENT | | | |
|------------------|------------------------|-----------------------|--|
| ITEM# | ITEM# QTY. DESCRIPTION | | |
| 1 | 1 | 24 UNIT FIRST AID KIT | |
| 2 | 2 | RESCUE TUBE | |
| 3 | 2 | REACHING POLE | |
| 4 | 1 | SPINE BOARD | |
| (5) | 1 | 24" LIFE RING | |
| 6 | 1 | HEAVING LINE | |
| 7 | 1 | FIRST AID BLANKET | |
| 8 | 1 | HEAD IMMOBILIZE | |
| 9 | 1 | SAFETY GOGGLES | |
| 10 | 1 | SAFETY GLOVES | |
| 11) | 1 LOT | POOL HANDRAIL * | |

* PROVIDE ALONG INTERIOR OF ENTIRE POOL WALL, LAVI INDUSTRIES $1\frac{1}{2}$ " ST. STEEK HANDRAIL OR EQUAL

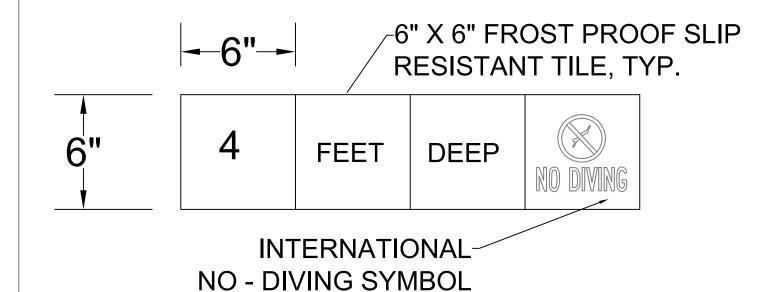


DEPTH MARKER DETAIL, RECREONICS 12622 OR EQUAL N.T.S.

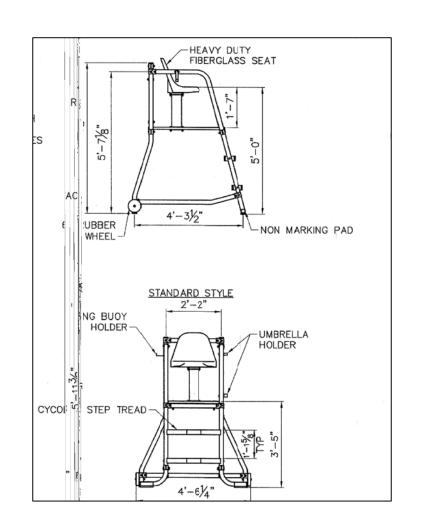

PORTABLE LIFEGUARD CHAIR DETAIL N.T.S.

| MAINTENANCE EQUIPMENT | | | |
|-----------------------|----------------------------|-------------------------|--|
| QTY. | CAT. NO. | LABEL | |
| 1 | REC. SUPPLY BB-2 105-0 | TAYLOR TEST KIT | |
| 1 | REC. SUPPLY CC-250-04 | VACUUM HEAD | |
| 1 | REC. SUPPLY CC-11715-15 | VACUUM HOSE | |
| 1 | REC. SUPPLY CC-1551550 | VAC. PUMP AND FILTER | |
| 1 | REC. SUPPLY CC-927C-2 | WALL BRUSH | |
| 1 | REC. SUPPLY CC-801F-50 | SKIMMER NET | |
| 1 | REC. SUPPLY CC-5F-99 | 8' POLE | |
| 1 | REC. SUPPLY CC-8MF-99 | 8' POLE | |
| 2 | REC. SUPPLY CC-P2516-50 | TELESCOPIC POLE | |

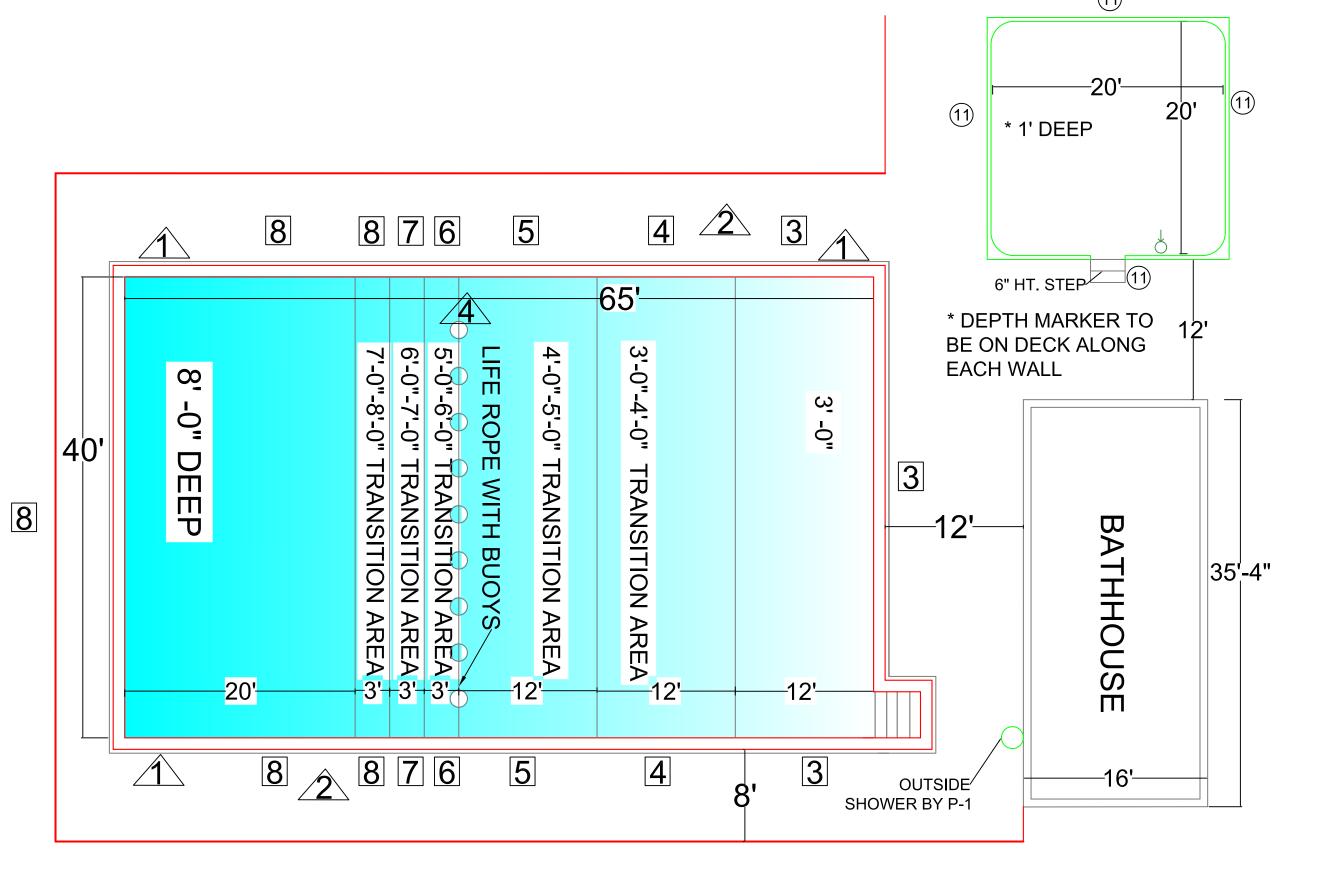

SWIMMING POOL PLAN VIEW (MARKINGS AND EQUIPMENT)


NOTE: BOTH POOLS WILL BE NEED TO BE CLOSED IN THE EVENT OF FECAL INCIDENT SINCE THE WADING POOL AND MAIN POOL ARE PROPOSED USE THE SAME TREATMENT SYSTEM AND SURGE TANK

| DECK EQUIPMENT | | | | | |
|----------------|-------|--------------------|--|--|--|
| ITEMS | LABEL | | | | |
| À | 3 | LADDERS | | | |
| <u>^2</u> | 2 | LIFEGUARD CHAIR | | | |
| 3 | 12 | DEPTH MARKERS | | | |
| <u> </u> | 1 | SAFETY ROPE | | | |

 $\frac{1}{16}$ " = 1'0

| DEPTH TABLE & DECK/WALL MARKERS | | | |
|---------------------------------|-----------------|-----------------------|--|
| ITEM# | QUANTITY MARKER | | |
| 3 | 2 | 3 FEET DEEP/NO DIVING | |
| 4 | 2 | 4 FEET DEEP/NO DIVING | |
| 5 | 2 | 5 FEET DEEP NO DIVING | |
| 6 | 2 | 6 FEET DEEP | |
| 7 | 2 | 7 FEET DEEP | |
| 8 | 2 | 8 FEET DEEP | |

* IDENTICAL MARKERS REQUIRED AT EACH LOCATION FOR BOTH DECK & WALL

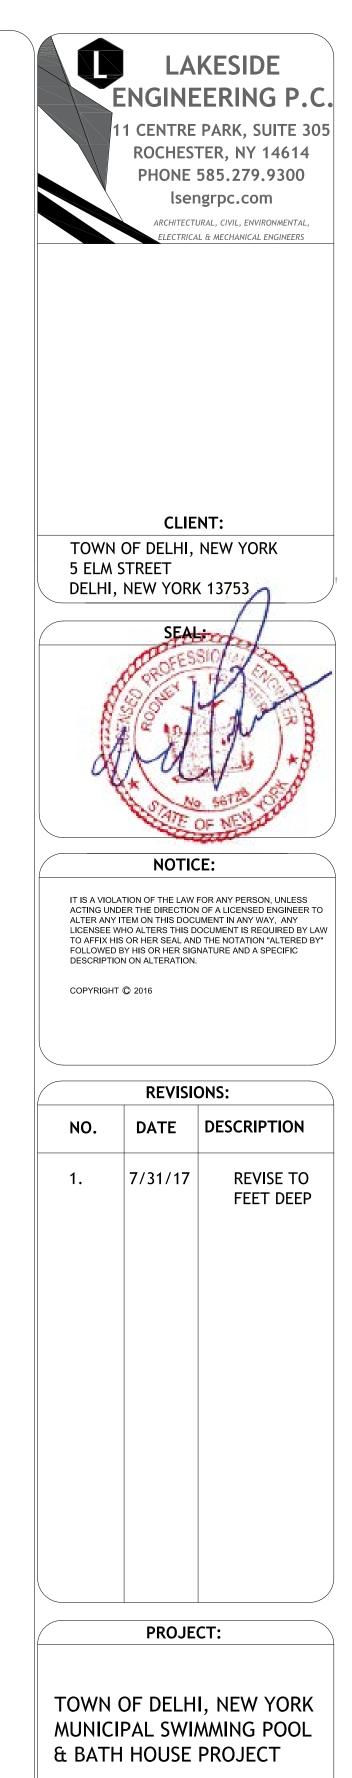

MUNICIPAL SWIMMING POOL & BATH HOUSE PROJECT


DRAWING TITLE:

POOL EQUIPMENT PLAN WORK & SUPPLY SCHEDULES

> **DRAWING NO:** 08/04/17

SECTION NO./ DRAWN BY: S.D./J.X. SHEET NO. REVIEWED BY: R.P./J.X.

SW-1/7 JOB ID: DT016-001

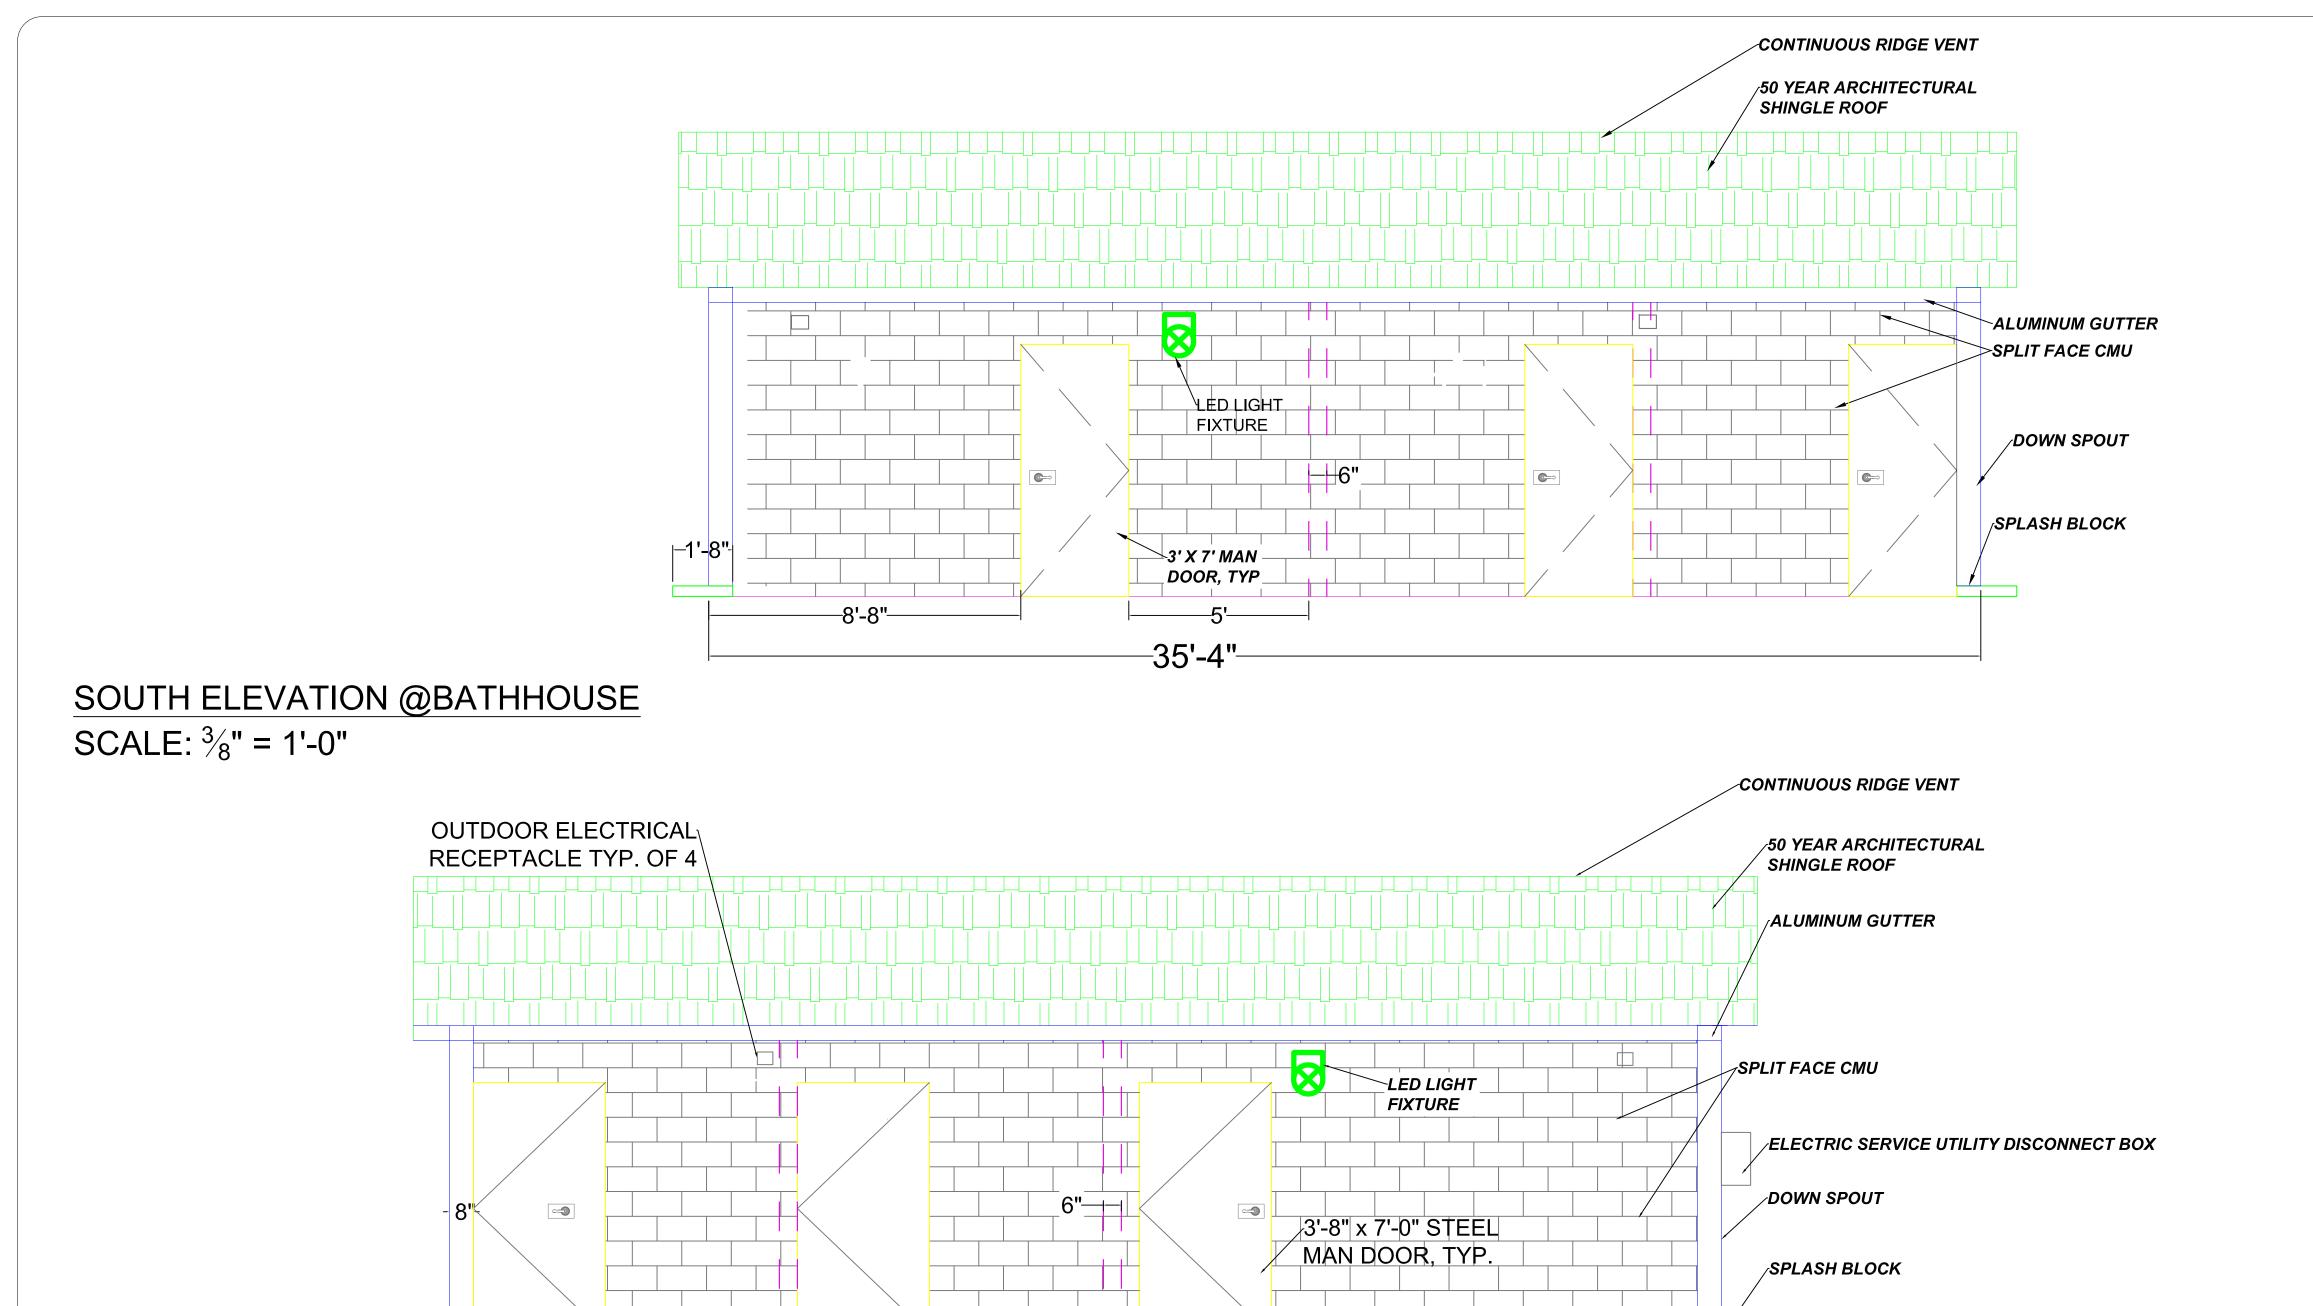


-35'-4"-


NORTH ELEVATION @ BATHHOUSE SCALE: $\frac{3}{8}$ " = 1'-0"

ALL DOWN SPOUTS

ON WALL CORNER + 4"+

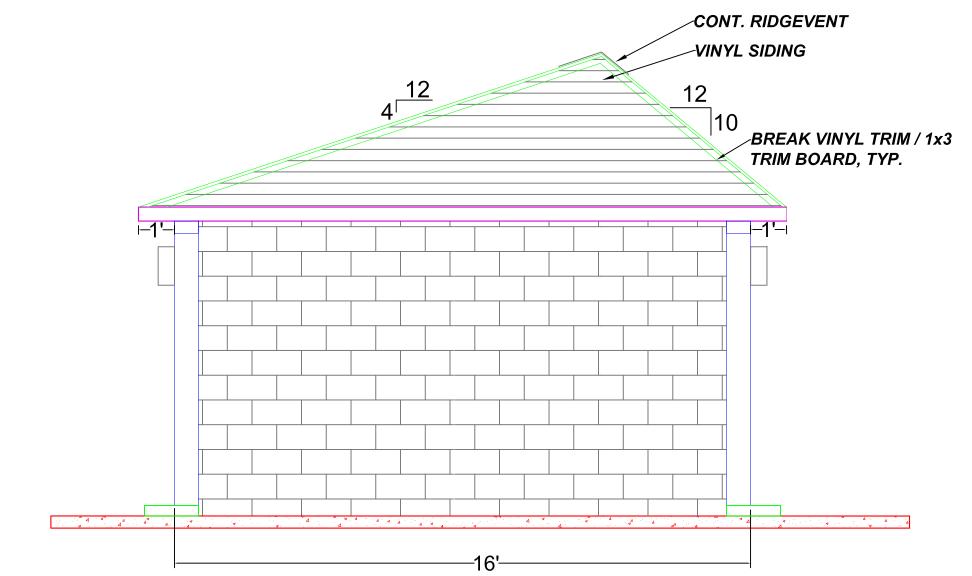



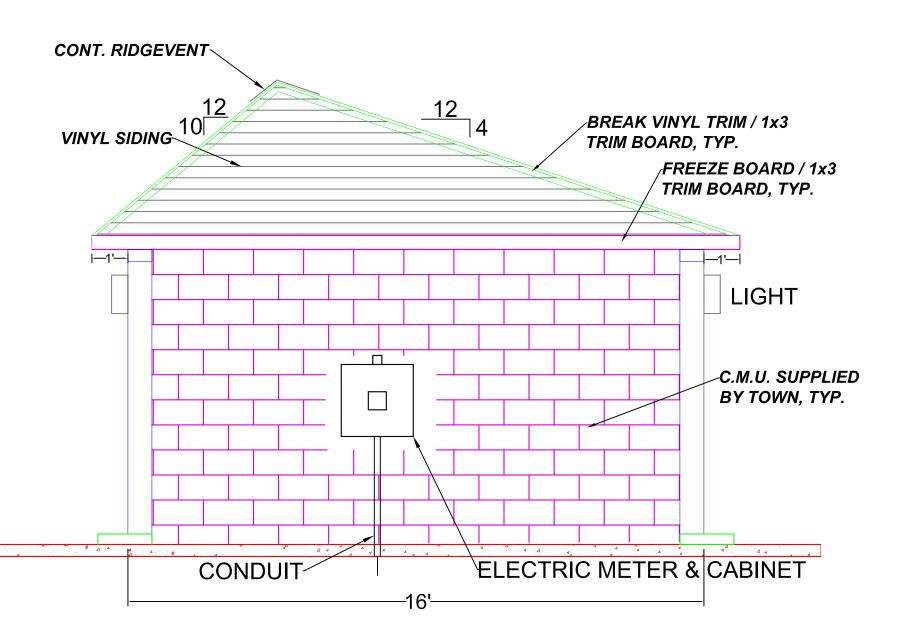


WEST ELEVATION @ BATHHOUSE SCALE: $\frac{3}{8}$ " = 1'-0"

ENGINEERING P.C. 1 CENTRE PARK, SUITE 305 ROCHESTER, NY 14614 PHONE 585.279.9300 lsengrpc.com

CLIENT:

TOWN OF DELHI, NEW YORK 5 ELM STREET DELHI, NEW YORK 13753

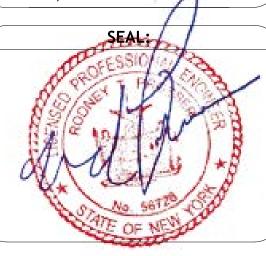

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REVISIONS: DATE DESCRIPTION

PROJECT:

TOWN OF DELHI, NEW YORK MUNICIPAL SWIMMING POOL & BATHHOUSE PROJECT

DRAWING TITLE:


BATHHOUSE ELEVATIONS

DATE: 03/22/17 $\frac{3}{8}$ " = 1'0


DRAWING NO: SECTION NO. /SHEET NO. DRAWN BY: J.L.M/J.X.

REVIEWED BY: R.P. JOB ID: DT016-001

A-1 /8

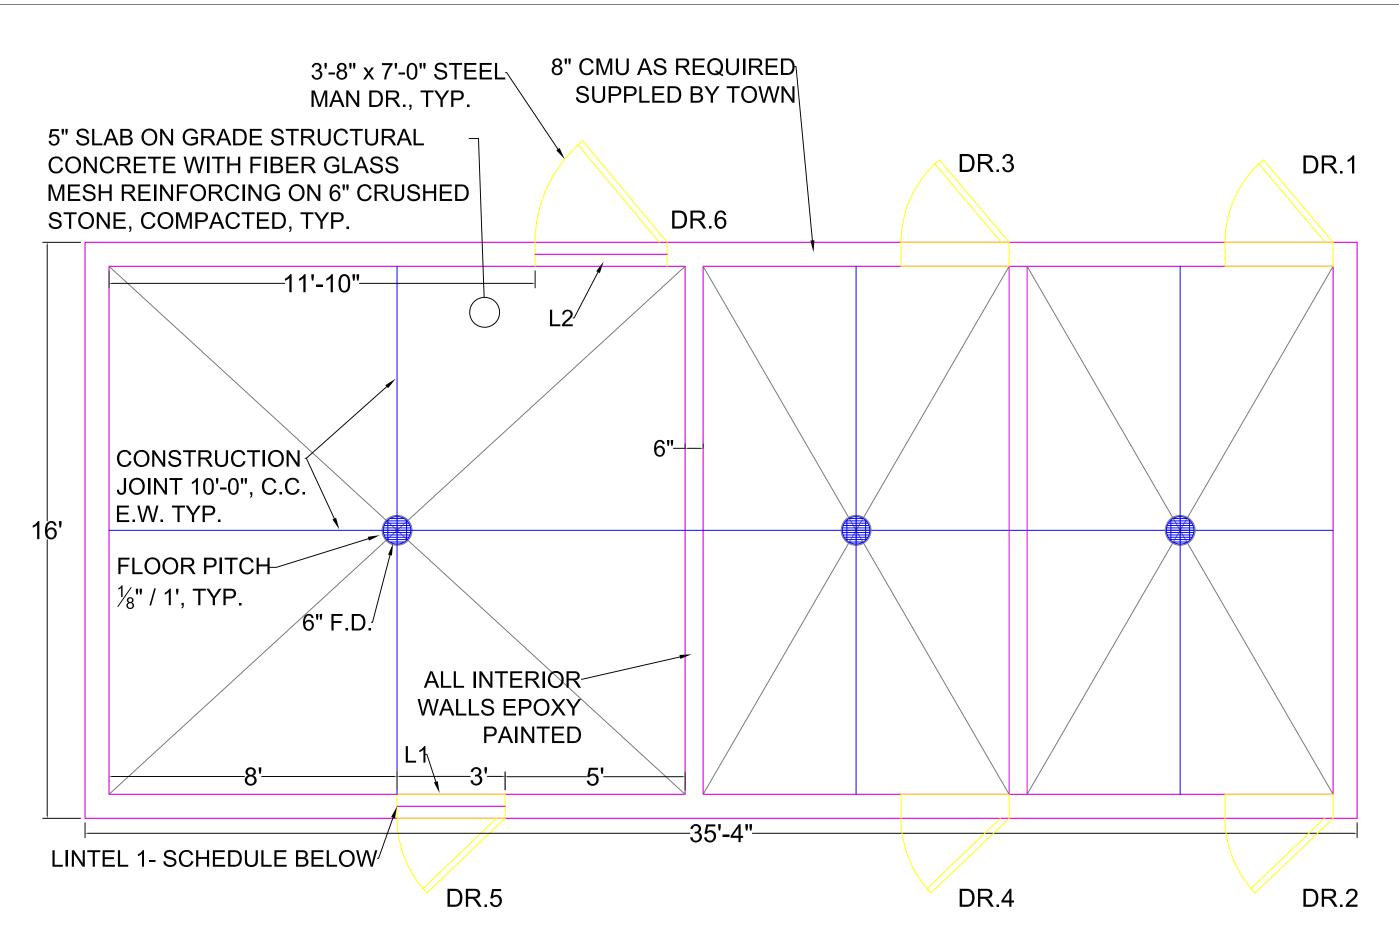

CONCRETE FLOOR SLAB, WALL & DOORS PLAN SCALE: 3/8" - 1'-0"

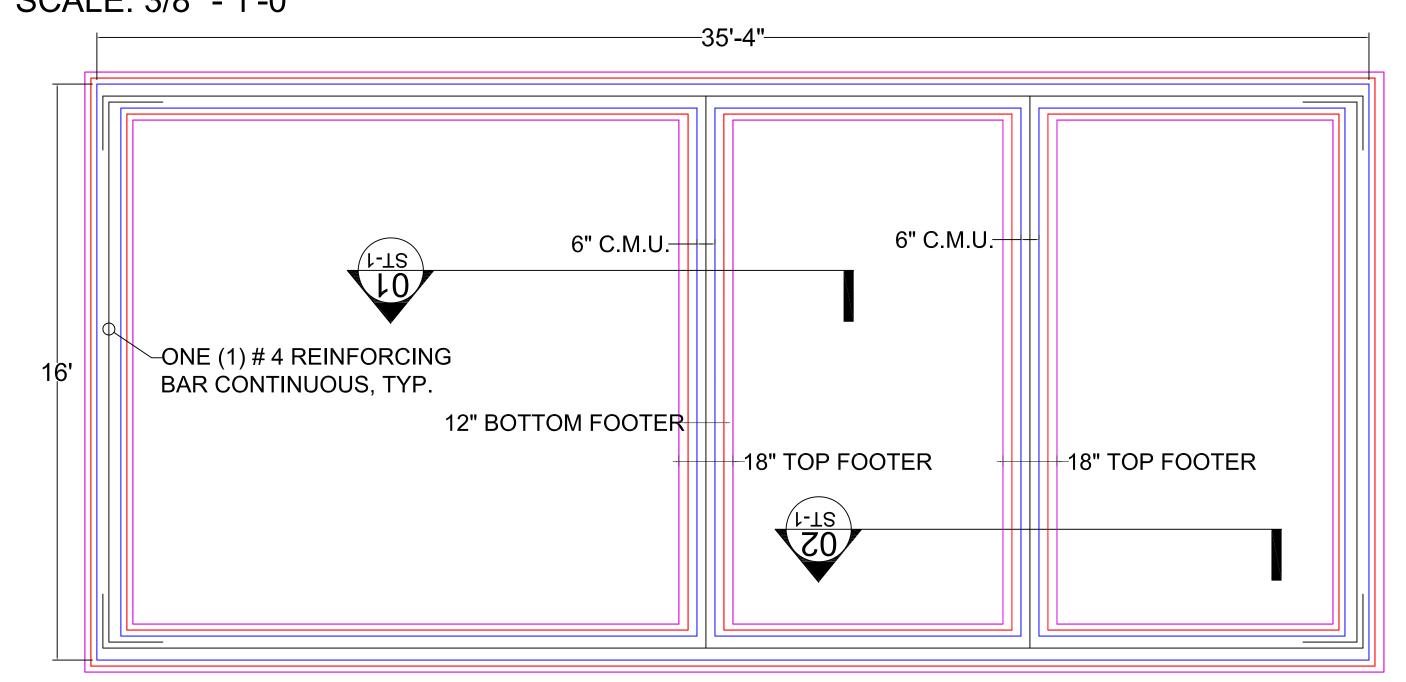


FOUNDATION PLAN

SCALE: 3/8" - 1'-0"

| LINTEL SCHEDULE* | | | | |
|------------------|----------|----------------------|-------|--|
| SYMBOL | NO. EACH | DESCRIPTION | FT. | |
| L1 | 5 | (2) 6" X 3 ½" X ¼" ∠ | 5'-0" | |
| L2 | 1 | (2) 6" X 3 ½" X ½" L | 6'-0" | |

∕8" SPLITFACE BLOCK THESE TWO (2) COURSES FILLED SOLID WITH GROUT (2) 6" X 3 $\frac{1}{2}$ " \angle TYP. **_LOWER BLOCK** FILLED SOLID -SAWCUT CMU TO ACCEPT LINTEL, TYP. \sim DOUBLE $3\frac{1}{2}$ "x6"x $\frac{1}{4}$ " STEEL, GALVANIZED, TYP., @ MAIN DOOR DOOR FRAME TACK WELD TOP DOOR FRAME TO LINTEL PRIOR TO PAINTING -METAL DOOR & FRAME STEEL LINTEL DETAIL

CMU WALL

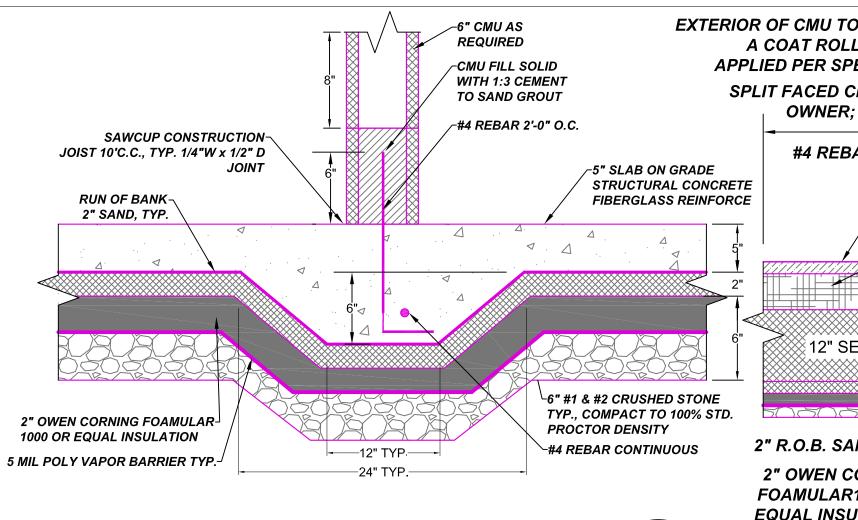

ALL WORK SHALL CONFORM TO THE NEW YORK STATE BUILDING CODE.

THE CONTRACTOR SHALL COORDINATE THE WORK WITH THE AUTHORITY

HAVING JURISDICTION, FOR PERIODIC INSPECTION AND ANY LIMITATIONS

DEBRIS AND LEAVE THE SITE IN A CLEAN AND ORDERLY CONDITION.

DO NOT OVER EXCAVATE UNDER FOUNDATIONS. BACKFILL AROUND

THAT MAY AFFECT THE PROJECT AREA AND/OR SCHEDULE. THE CONTRACTOR

AFTER COMPLETION OF THE PROJECT, THE CONTRACTOR SHALL REMOVE ALL

FOOTINGS SHALL BE PLACED ON UNDISTURBED GRADE OR ENGINEERED FILL

FOUNDATIONS UNDER SLAB ON GRADE WITH ENGINEERED FILL. ENGINEERED

CONCRETE WORK SHALL CONFORM TO ACI 318. FORMS SHALL BE TRUE AND

STRAIGHT.USE ONLY SNAP TIES. PATCH RECESSED TIE ENDS WITH A HIGH

BARS - ASTM A 615, GR 60, DEFORMED

MESH - ASTM A 185 OR FIBERGLASS

NORMAL WEIGHT AGGREGATE - C33

WATER REDUCING ADMIX - ASTM C 492, TYPE D

3.3 CONCRETE MIX SHOULD BE AS FOLLOWS:

READY MIX CONCRETE SHALL CONFORM TO C 94

3.4 WATER REDUCER: SEE SPEC. SECTION 03300

-CURE SLAB WITH WATER SPRAY OR CLEAR COMPOUND

-SAW-CUT RELIEF JOINTS AS SOON AS CONCRETE HAS SET.

SLAB ON GRADE, SIDEWALK & FOUNDATION

PLACE SLAB IN A CONTINUOUS OPERATION.

FINISH SURFACE - LIGHT BROOM FINISH F25.

FINISH FLOOR - COMPLY WITH ACI 302.1R

-SLOPE SLAB TO DRAINS AT1/4" / FT.

FILL SHALL BE COMPACTED IN 6" LAYERS HAVING A STANDARD PROCTOR

SHALL CONFORM TO ALL SAFETY PROVISIONS, LOCAL, STATE AND FEDERAL

SECTION OF INTERIOR FOOTER/LOWER WALL ST-1/ N.T.S.

GENERAL NOTES

DENSITY OF 100 (MAXIMUM COMPACTION).

3.1 REINFORCING

3.2 CONCRETE MATERIAL

MAX AGGREGATE SIDE - 1"

WATER - CLEAN, POTABLE

AIR ENTRAINMENT 6%.

AIR ENTRAINMENT - ASTM C 260

4000 PSI @ 28 DAYS W/C RATIO.40,

FLYASH - ASTM C 618

CEMENT - ASTM C 150, TYPE II

STRENGTH NON SHRINK GROUT.

1. GENERAL

2. FOUNDATIONS

3. CONCRETE WORK

EXTERIOR OF CMU TO BE SEALED WITH −8" CMU AS A COAT ROLLED ON OR SPRAY REQUIRED APPLIED PER SPEC.09900. TYPICAL -CMU FILL SPLIT FACED CMU FURNISHED BY **SOLID WITH 1:3 OWNER**; **INSTALLED BY G-1 CEMENT TO** SAND GROUT #4 REBAR CONTINUOUS--#4 REBAR 2'-0" O.C. -5" SLAB ON GRADE -SEED TO GRASS STRUCTURAL CONCRETE 4" TOP SOIL FIBERGLASS REINFORCE 12" SELECT SOIL MINIMUM 6"#1 & #2 CRUSHED 2" R.O.B. SAND, TYP. STONE TYP., COMPACT TO 100% 2" OWEN CORNING-STD. PROCTOR DENSITY FOAMULAR1000 OR **EQUAL INSULATION** ∽5 MIL POLY VAPOR BARRIER TYP.

SECTION OF EXTERIOR FOOTER/LOWER WALL N.T.S.

2500 - PSI PRISM STRENGTH - ASTM C 1314

REINFORCING FOR BOND BEAM - ASTM A 615

AGGREGATE FOR GROUT - ASTM C 404

CMU - ASTM C 90, INTEGRATED COLORED.; COLOR TO BE

WATER REPELLENT ADMIXTURE - RAIN BLOCK BY BLOCK

WATER PROOF SEALANT ADDED TO EXTERIOR OF CMU EXTERIOR

LADDER TYPE OR TRUSS TYPE JOINT REINFORCING EVERY 3RD

-COORDINATE WITH ELECTRIC CONTRACTOR FOR WIRING

OVER OPENING. PAINT INTERIOR WALLS AS SPECIFIED

FLASHING - FLEX FLASH BY HOHMANN & BARNARD OR EQUAL

-ALL TIMBER IN CONTACT WITH CONCRETE, CMU OR EARTH

-ANCHOR PLATES TO CMU WITH 1/2" HOOKED BOLTS @ 4' C/C

-ROOF TRUSSES SHALL BE PRE-ENGINEERED, 60 LB./SF L.L &

4. MASONRY

FACE

COURSE

5. TIMBER

20 LB./SF. DL

SELECTED BY OWNER.

M OR S TYPE MORTAR

ST-1

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RIVISIONS:

CERTIFY DESIGN.

-A REGISTERED ENGINEER IN THE STATE OF NEW YORK SHALL

-FASTEN WOOD TRUSSES TO THE WALL PLATE WITH GALV. -HURRICANE TIES WITH 200 LB ANCHOR CAPACITY.

-PLYWOOD SHALL BE CDX OR EQUAL.

-FASTEN WOOD CONNECTION PER CODE TABLE 2304.9.1 -STRUCTURAL FRAMING - HEM FIR OR SOUTHERN PINE STRUCTURAL SELECT.

TRIM - ARCHITECTURAL GRADE

SHALL BE PRESSURE TREATED.

6. ROOFING

50 - YEAR ARCH SHINGLES, OWNER TO SELECT COLOR ICE AND WATERSHED UNDERPAYMENT PER CODE.

7. DOORS

-ENTRANCE DOORS (SINGLE DOOR) INSULATED 3'-0" X 7'-0" X 2" THICK. GALVANIZED STEEL DOOR OR EQUAL EXCEPT GATES ENTRY ROOM-DOORS TO HAVE ADA APPROVED HANDLES. PAINT AS SPECIFIED - SEE DOOR & HARDWARE SPECIFICATIONS FOR FURTHER REQUIREMENTS.

8. FOAMULAR 1000 OR EQUAL FOAM BOARD INSULATION, 1000 PSI COMPRESSIVE STRENGTH & 10 PCF VVT

RIGID INSULATION:

SHALL ALL BE OWENS CORNING FOAMULAR O.C.F. 1000 OR EQUAL. 3 PCF DENSITY, 100 OR EQUAL PSI COMPRESSIVE STRENGTH, CLASS V

DATE: 06/22/17 $\frac{1}{2}$ = 1'-0" DRAWN BY: J.L.M/J.X.

NO./SHEET NO. ST-1 / 9 REVIEWED BY: R.P. JOB ID: DT016-001

XPS (EXPANDED POLYSTYRENE.)

CLIENT: TOWN OF DELHI, NEW YORK **5 ELM STREET**

LAKESIDE

ENGINEERING P.C.

1 CENTRE PARK, SUITE 305

ROCHESTER, NY 14614

PHONE 585.279.9300

lsengrpc.com

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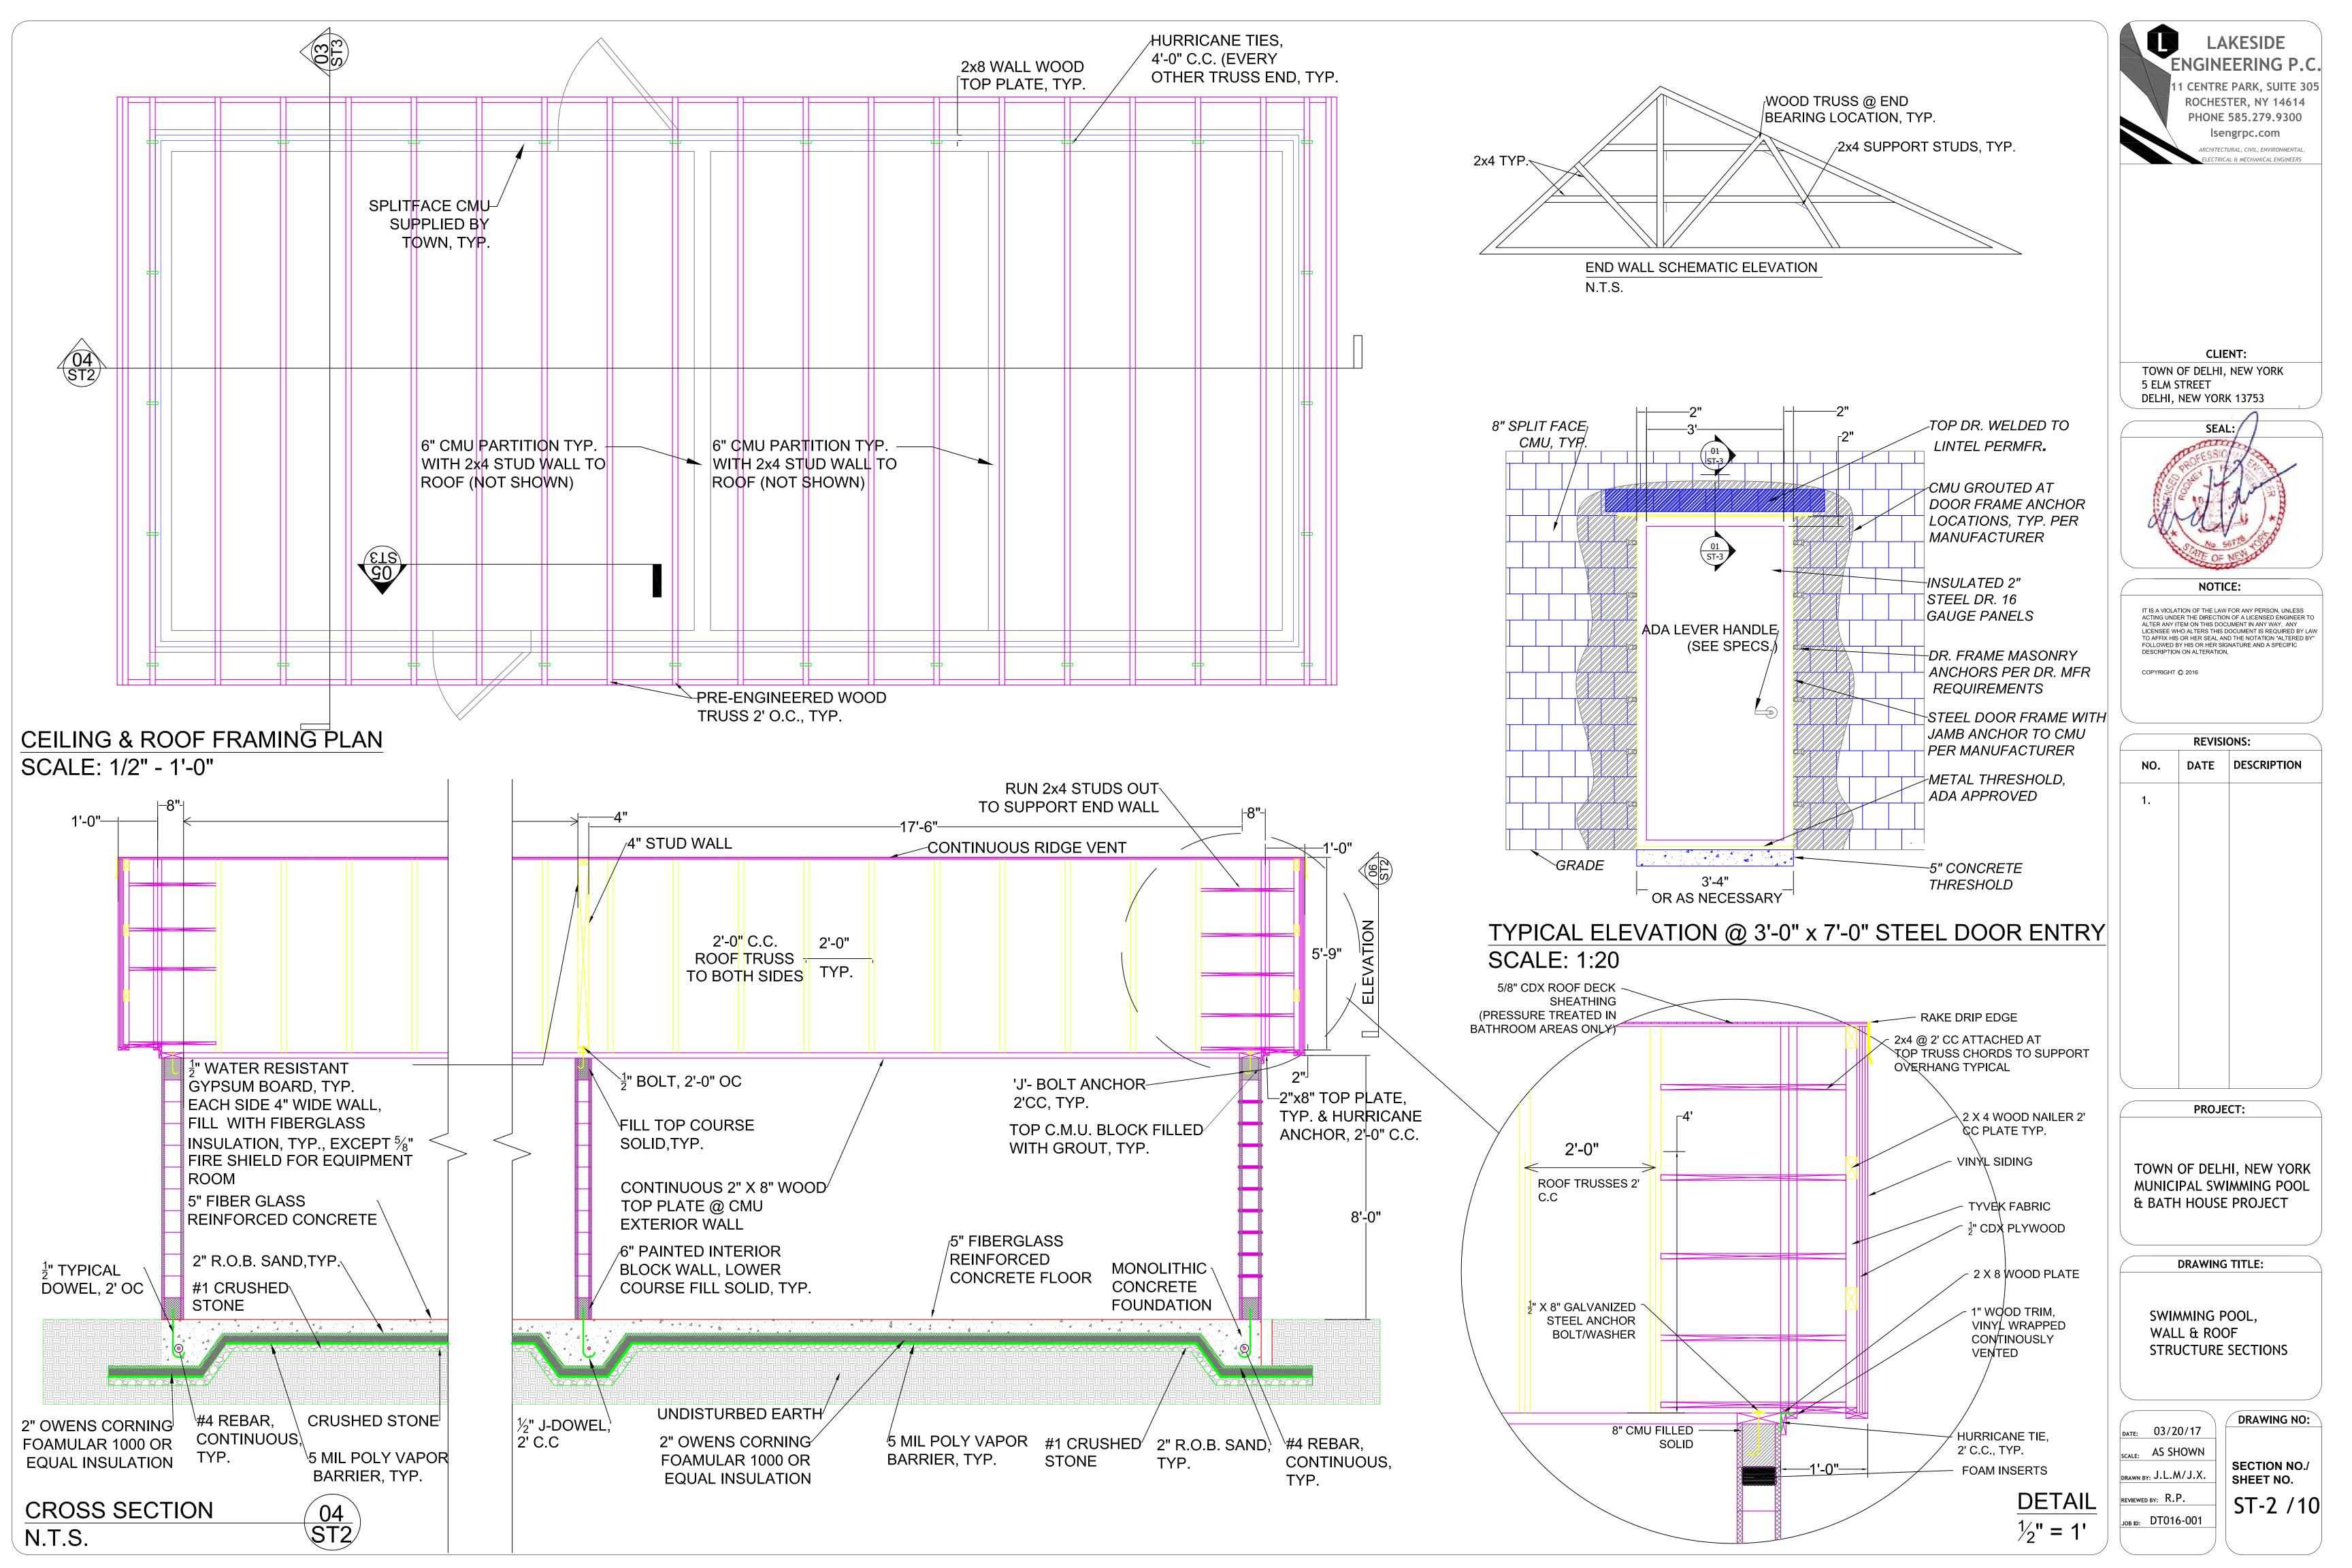
TOWN OF DELHI, NEW YORK MUNICIPAL SWIMMING POOL & BATH HOUSE PROJECT


DRAWING TITLE:

FLOOR SLAB, WALL/DOORS & FOUNDATION PLAN, SECTIONS & NOTES

> **DRAWING NO:** SECTION

* ALL LINTELS HOT DIPPED GALVANIZED



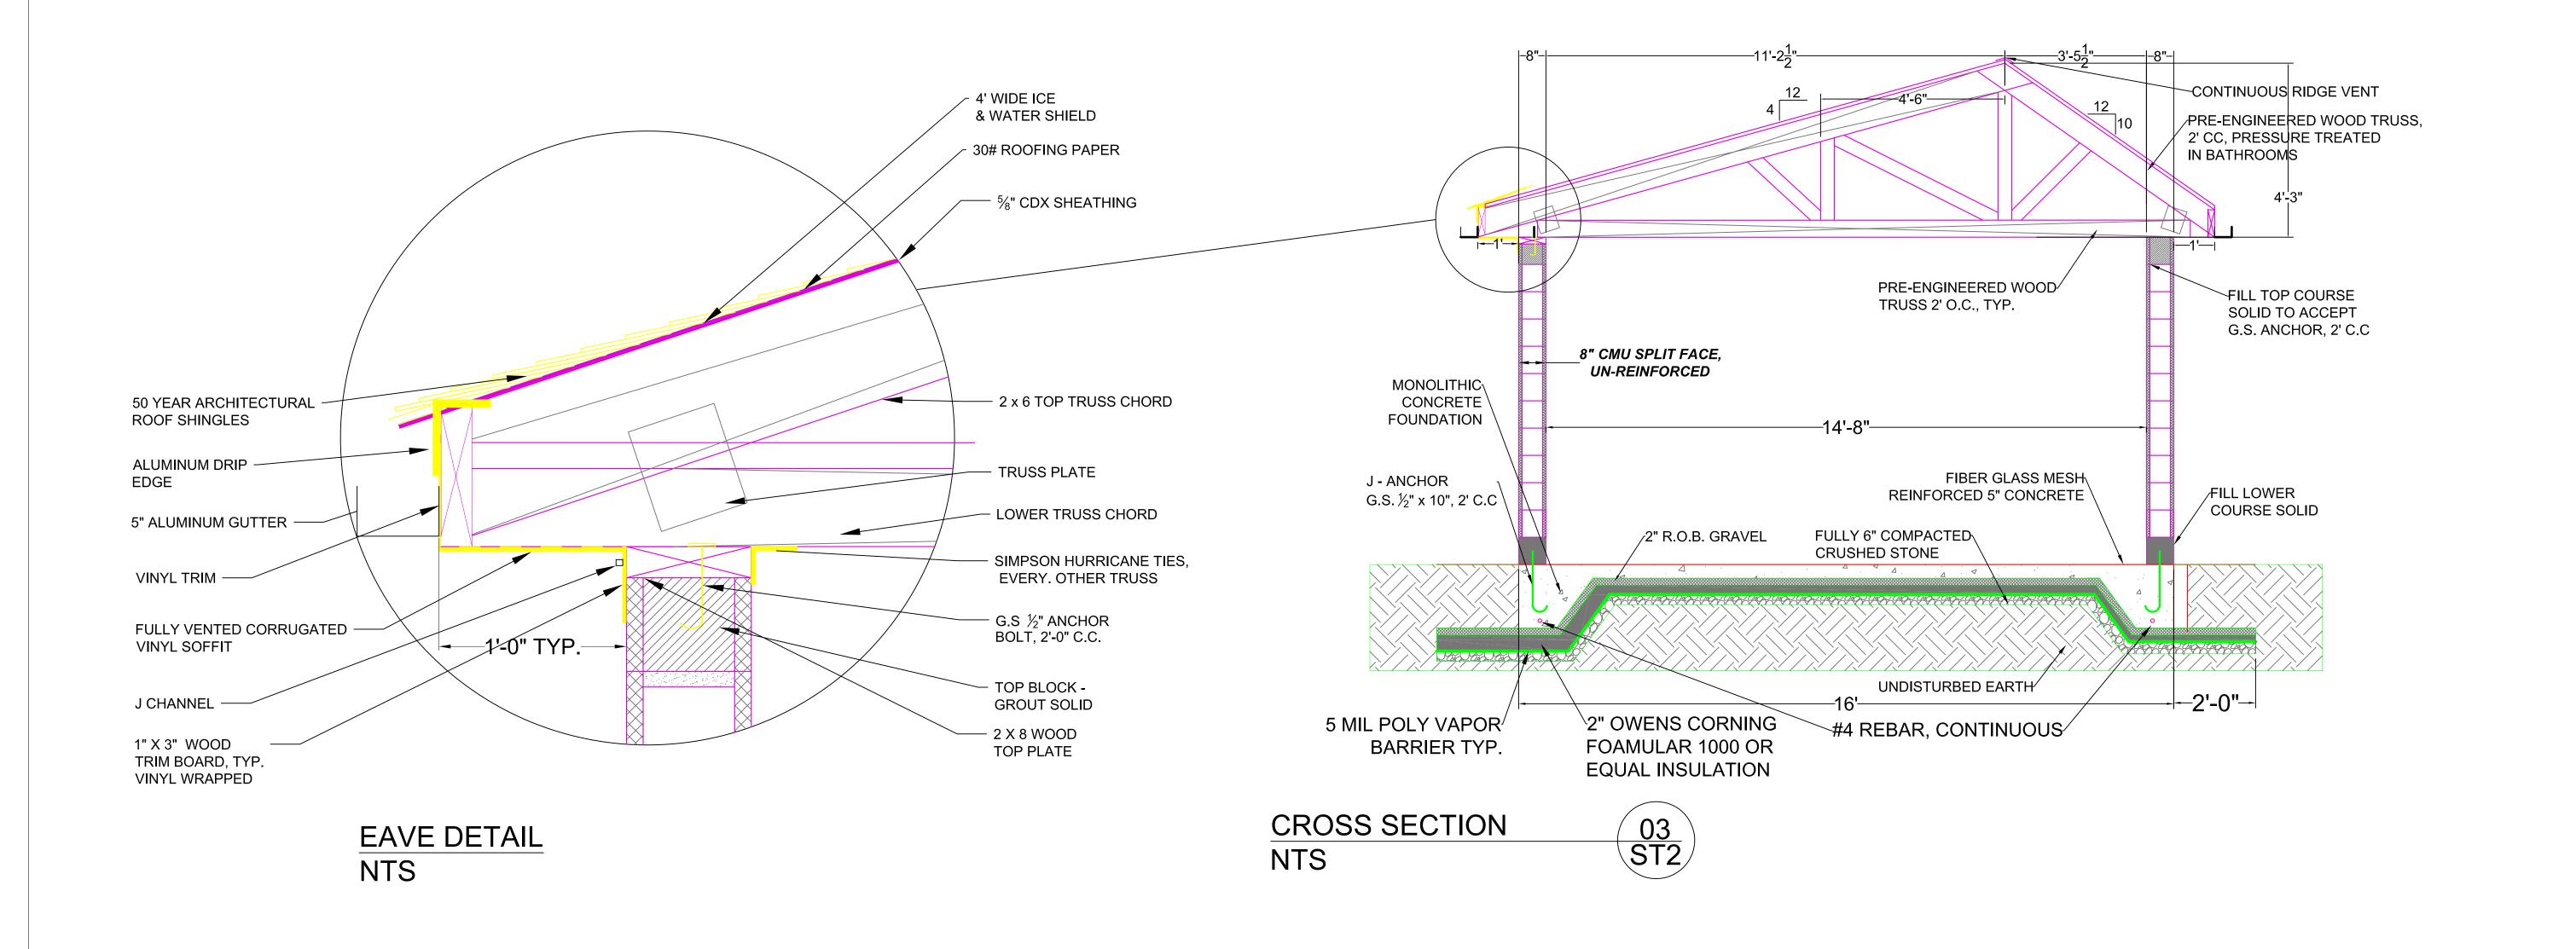

LAKESIDE
ENGINEERING P.C.

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ROCHESTER, NY 14614
PHONE 585.279.9300
Isengrpc.com

ARCHITECTURAL, CIVIL, ENVIRONMENTAL,
ELECTRICAL & MECHANICAL ENGINEERS

CLIENT:
TOWN OF DELHI, NEW YORK
5 ELM STREET

5 ELM STREET DELHI, NEW YORK 13753

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PROJECT:

TOWN OF DELHI, NEW YORK MUNICIPAL SWIMMING POOL & BATH HOUSE PROJECT

DRAWING TITLE:

BATHHOUSE ROOF DETAILS


DATE: 03/20/17SCALE: $\frac{1}{2}$ " = 1'-0"


DRAWN BY: J.L.M/J.X.
REVIEWED BY: R.P.

JOB ID: DT016-001 ST-3 /11

DRAWING NO:

SECTION NO. /

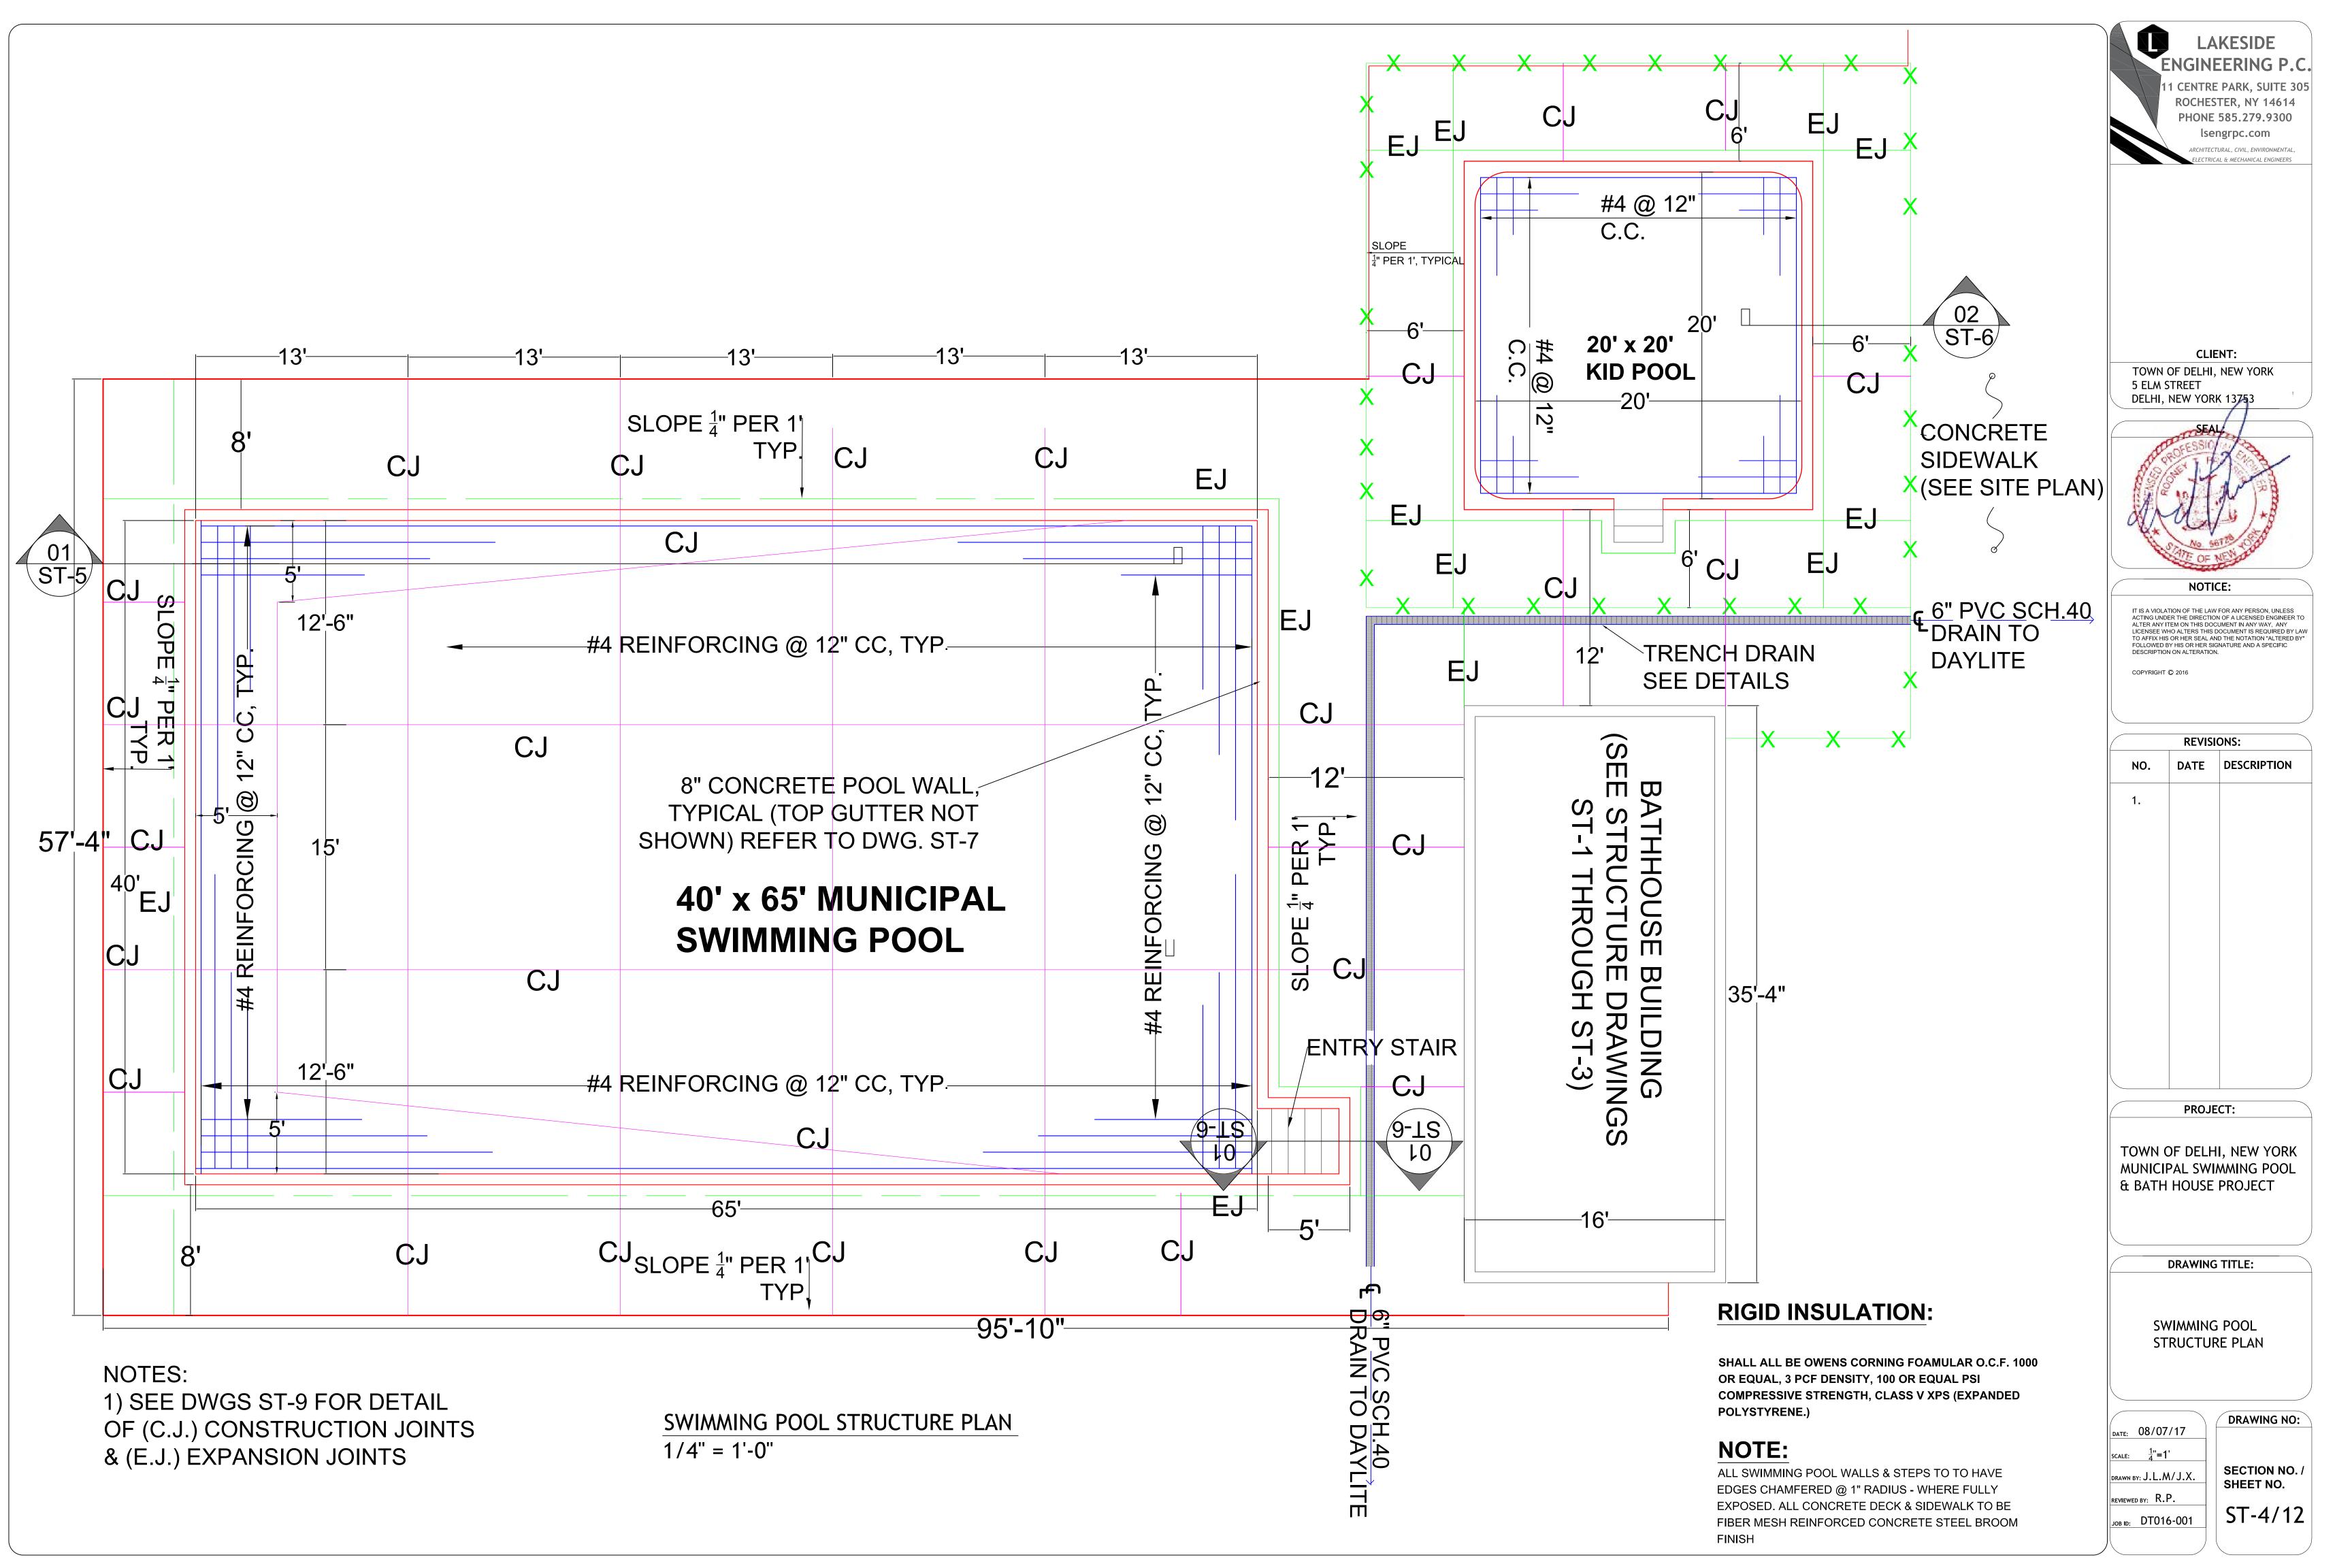

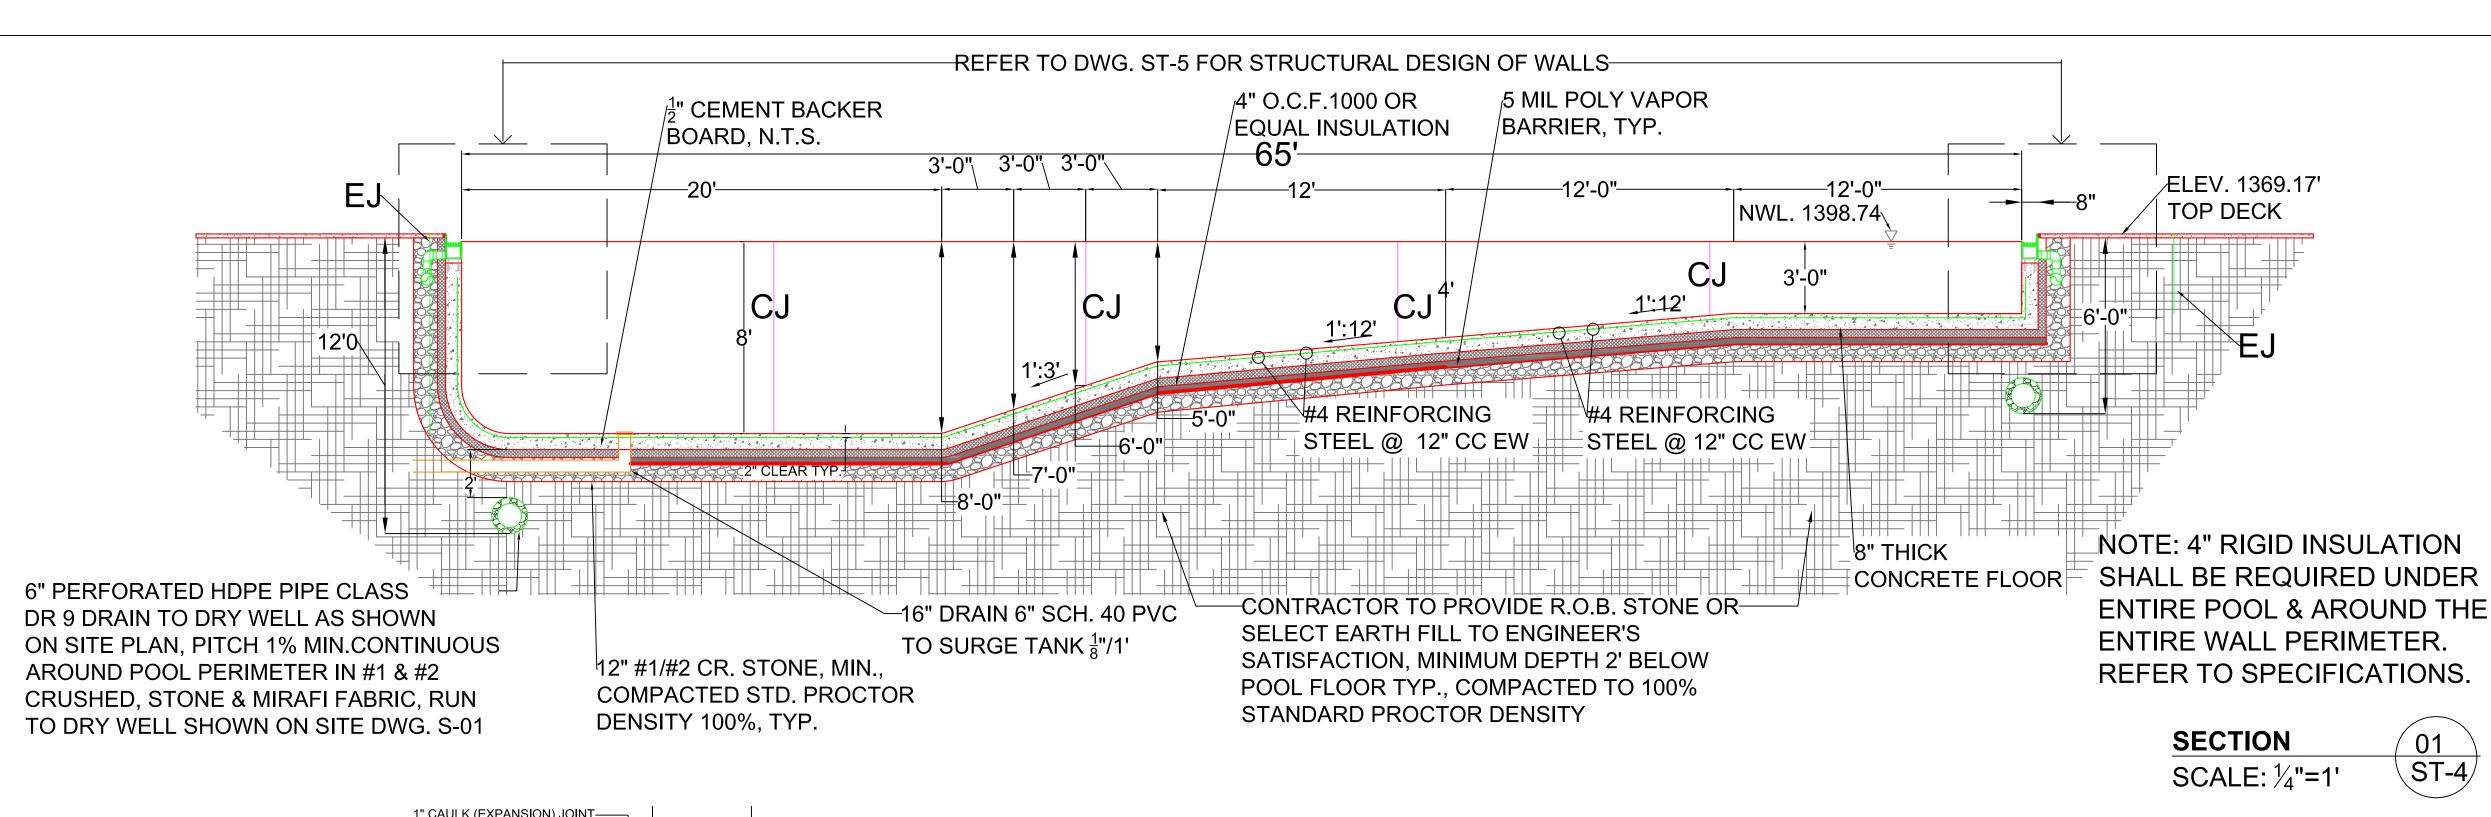

NOTES:

1) ALL REBAR LAPS 1'- 6" MIN. UNLESS NOTED OTHERWISE.

2)12" PVC WATERSTOPS REQUIRED @ ALL COLD JOINTS AND AS PER PLAN

3) ALL REINFORCEMENT TO BE ASTM 36. DEFORMED STEEL BARS

4) ALL CONCRETE FOR SWIMMING POOL MIN. 4000 PSI AIR ENTRAINED, TROWELED OR SHOTCRETE & IMMEDIATELY RUBBED SMOOTH AS SOON AS FORMS CAN BE REMOVED

5)ALL SWIMMING POOL FLOOR & WALLS TO BE PLASTERED EXCEPT WHERE TILE IS REQUIRED REFER TO SPECIFICATIONS SECTION09900

6) SWIMMING POOL TILE REQUIRED AT 5' FLOOR DEPTH ONLY, SEE DETAIL, DWG SW-1

7) ALL EXPOSED CONCRETE WALL CORNERS & STEPS SHALL HAVE 1" RADIUS CHAMFERED CORNER

8) ENTIRE INTERIOR OF SWIMMING POOL SHALL BE PLASTERED PER SPECIFICATION SECTION ON 09900 & MFR. RECOMMENDATIONS, COLOR TO BE CHOSEN

1" CAULK (EXPANSION) JOINT-4" CONCRETE DECK SLOPE 1/4" PER 1' TO YARD 3" SCH. 40 ST. STEEL -FIBERGLASS GRATING BY GUTTER MFR. NONSHRINK GROUT PER STAINLESS STEEL GUTTER MFR. 4" O.C.F. 100 OR **EQUAL INSULATION** 1½" ADJUSTABLE 1¹/₂" PVC, SCH. 40— JĒT INLET, TYP. 1<mark>1</mark>" 90° BEND VARIES 3'-0"- 3' -1" DEEP DRAIN LINE (ONE CONTINUOUS POUR BETWEEN PVC WATER STOP) RECIRCULATION—(\ MAIN LINE BEND 3" MIN SAND 18" LAP, TYP. #4 @ 12" OCE r_{2}^{1} " CEMENT BACKER BOARD FOR FLOOR, SELECT EARTH 3" SS, SCH. TO 3"^J 4" FLOOR & WALL INSULATION WITH MECHANICAL ~#4, 12" C.C., TYP. OR CRUSHED FASTERNERS, WITH OVERSIZE WASHERS TAPCON PVC, SCH40 ADAPTOR STONE PER -12" PVC WATERSTOP, OR EQUAL. 2' C.C. PLUS GLUE. UNDER ALTERNATE 'ADDER' BID, SEE SPECS. 8" THICK CONCRETE FŁOOR —4" INSULATION, NOTE: **TYPICAL** REFER TO DRAWING ELEVATIONS & PLAN FOR ALL EXTERIOR PIPING TO HAVE MAIN SIZES & DEPTHS. ADJUST RISER LT. AS NECESSARY AT EACH DRAIN / INLET 2" HARD RUBBER INSULATION +

4" 90° PVC-1" CAULK JOINT--4" PVC: LENGTH 1 ½" LONG 4" PVC **VARIES** -4" x X" PVC TEE: SECONDARY PIPE ADAPTOR-1" COMPRESSIBLE-DIAMETER VARIES FOAM 4" FIBERGLASS REINFORCED 3" LONG 2" ST.STEEL PIPE CONCRETE DECK 8" FIBERGLASS GRATING-S.S. GUTTER-NONSHRINK-GROUT CENTER 1 1/2" COUPLING-FULLY COMPACTED (WATER STOP) R.O.B. STONE OR **ENGINEER APPROVED** 1 ½" SCH. 40 SELECT EARTH THROUGH WALL ADJUSTABLE JET-SAND ENCASEMENT OF PVC PIPING 12" PVC WATER STOP-@ COLD JOINT, TYP POOL GUTTER DRAIN PITCH 1% TO SURGE TANK TYP. SEE DWG. SPP-1 FOR LOCATION, #4 @ 12" C.C. EW, TYP., SIZE VARIES 4" - 8" 2" MIN. √8" THICK POURED CLEARANCE / CONCRETE FLOOR (VARIES 3' TO 8' DEEP) 1 ½" X VARIES" PVC TEE. TYP. ∼PITCH DOWN TO PUMP IN **EQUIPMENT BUILDING** ON TOP OF SAND BEDDING (RETURN WATER LINE -SEE DWG. SPP-1 FOR SIZE & LOCATION) PVC WATER STOP @ COLD JOINT, TYP. ~#4 @ 8" C.C. EW MIN. 12" COMPACTED **CRUSHED STONE** NATIVE SOIL -5 MIL POLY VAPOR BARRIER FULLY ADHERED -4" OCF 1000 OR EQUAL **FULLY ADHERED TO WALL** COMPRESSIBLE FOAM TO BE LIGHT WT. WHITE CRUSHED STONE COMPACTED TO STYROFOAM OR EQUAL 100% STANDARD PROCTOR

STAINLESS STEEL GUTTER DETAIL, TYPICAL N.T.S.

PVC JACKET, INCLUDING ALL

ALTERNATE BID

FITTINGS & SPECIALS, UNDER

RIGID INSULATION:

SHALL ALL BE OWENS CORNING FOAMULAR O.C.F. 1000 OR EQUAL, 3 PCF **DENSITY, 100 OR EQUAL PSI** COMPRESSIVE STRENGTH, CLASS V XPS (EXPANDED POLYSTYRENE).


TYPICAL POOL SECTIONS AT WALL (3'-0" - 8'-0" DEPTH) N.T.S.

DENSITY.

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PROJECT:

TOWN OF DELHI, NEW YORK MUNICIPAL SWIMMING POOL & BATH HOUSE PROJECT

DRAWING TITLE:

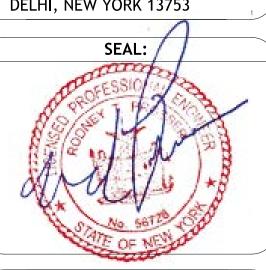SWIMMING POOL STRUCTURE SECTIONS & GUTTER DETAIL

03/20/17 AS SHOWN DRAWN BY: J.L.M/J.X.

REVIEWED BY: R.P.

JOB ID: DT016-001


SECTION NO./ SHEET NO. ST-5 /13


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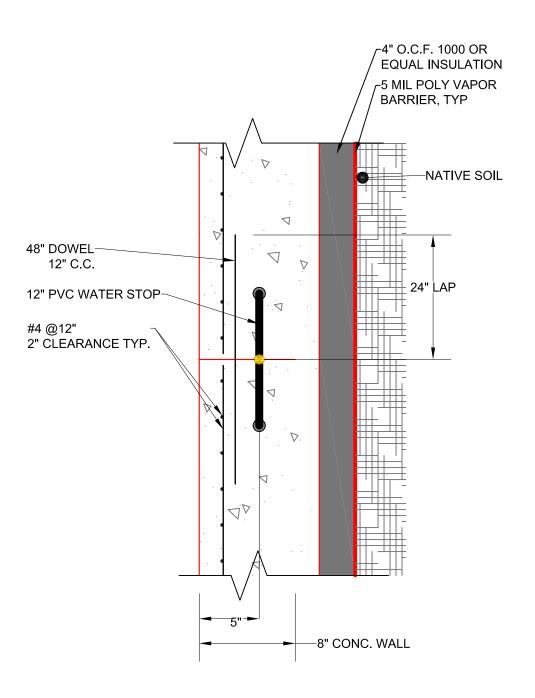
2) SEE DWGS. SPP-1, SPP-3, & SPP-5 FOR EMBEDDED PIPING


1) HANDRAIL NOT SHOWN


NOTES:



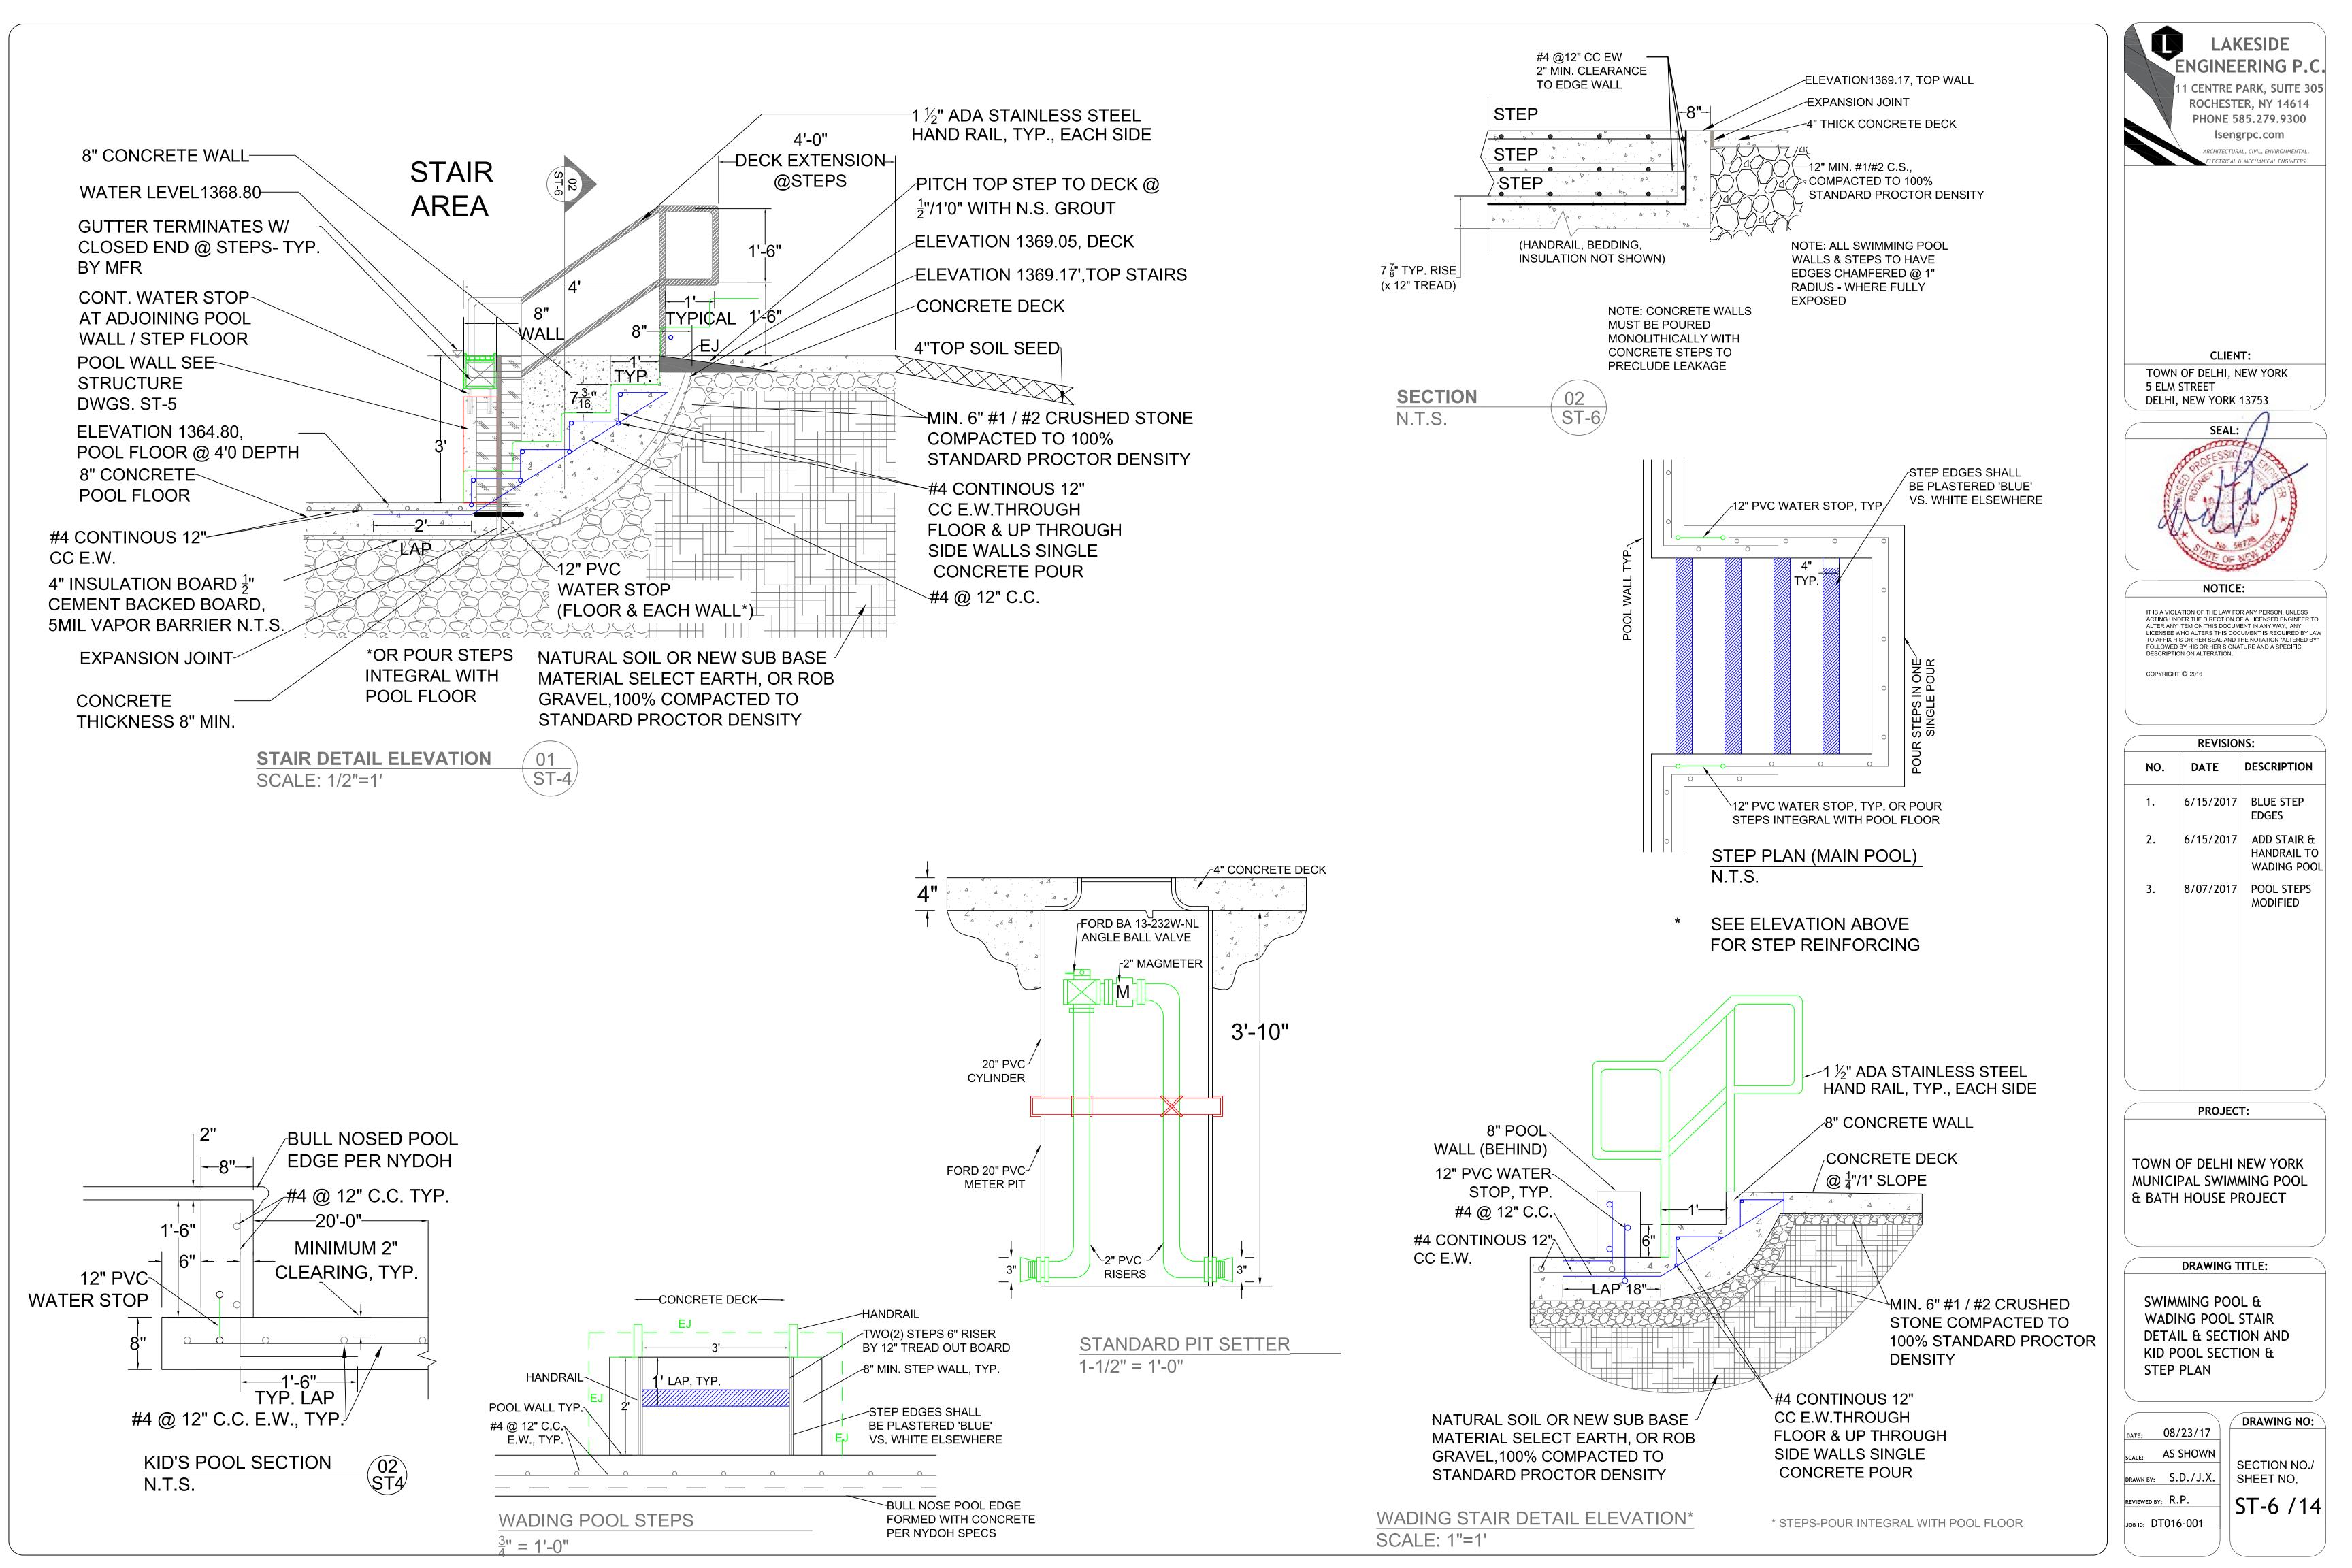


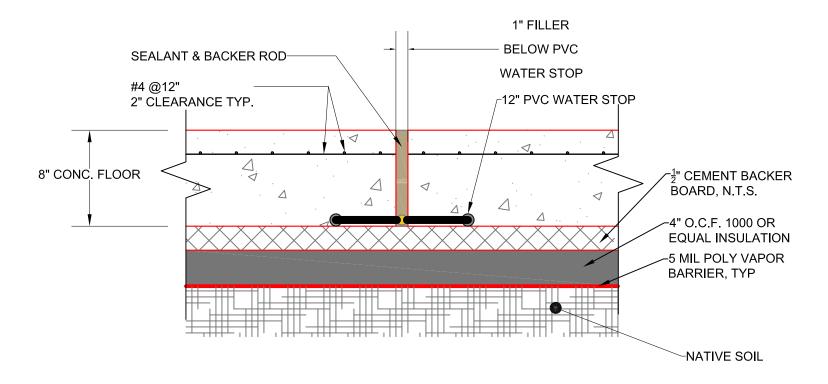

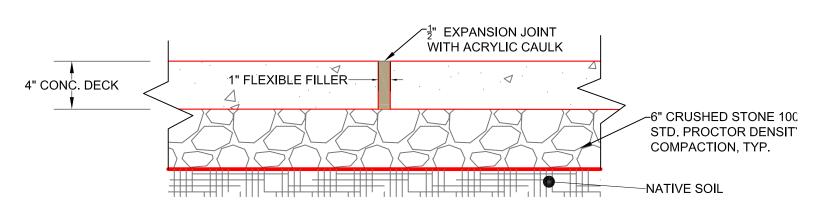

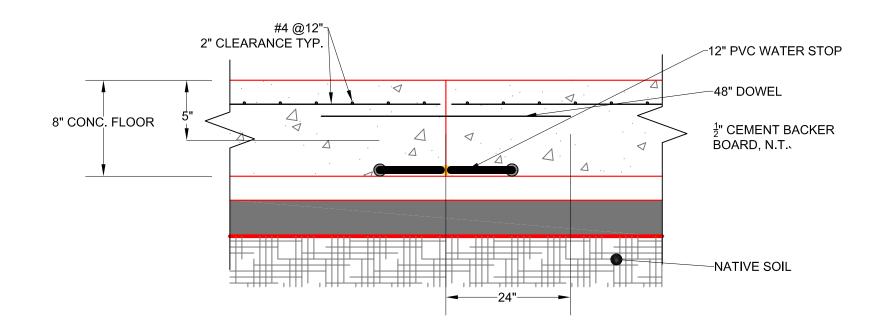



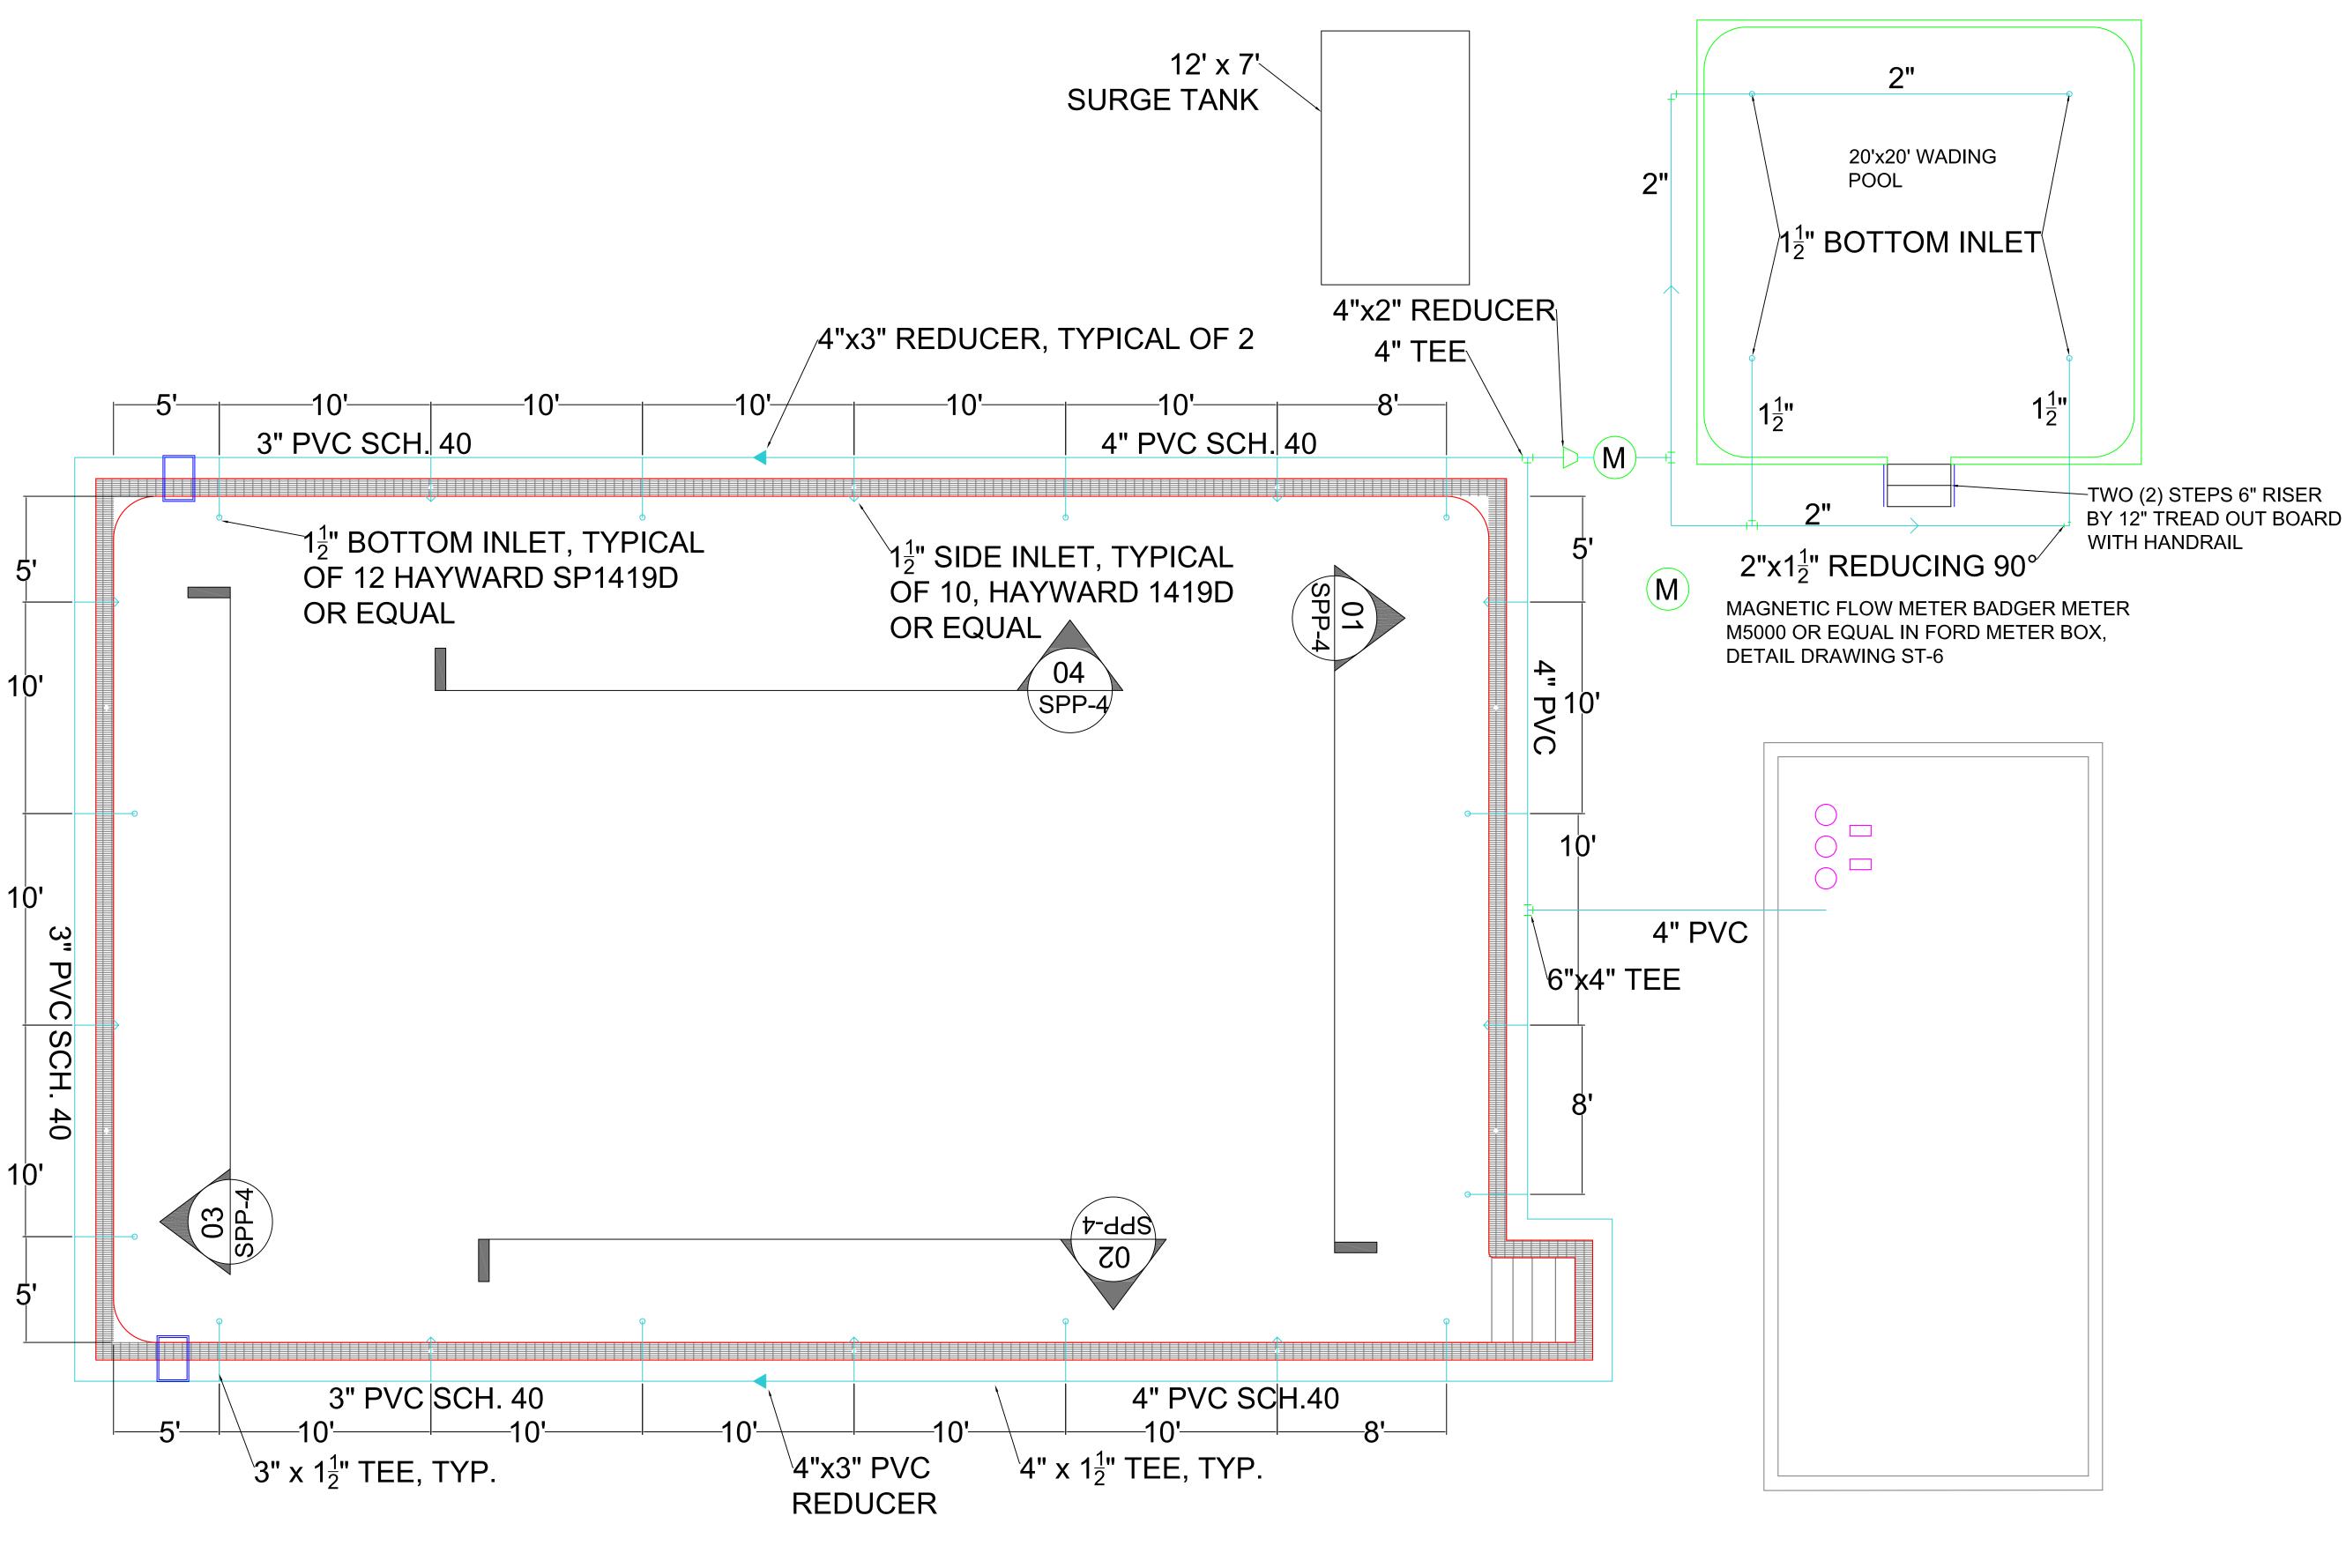

NOTE:

- ALL POOL RECIRCULATION INLET JETS SHALL HAVE MIN. 3" WIDE $x_{\frac{1}{2}}$ " THICK BENTONITE FABRIC WATER STOP WRAPPED & BANDED AROUND PIPING IN WALL WHETHER OR NOT SHOWN ON DWGS.
- 2. ALL RECIRCULATION LINES, FITTINGS, & SPECIALS TO BE INSULATED WITH 2" HARD RUBBER, PVC JACKETED BY AEROFLEX USA UNDER RECIRCULATION PIPING INSULATION ADDER BID.
- 3. WADING POOL SKIMMERS TO BE HAYWARD SP1070 OR EQUAL

SWIMMING POOL PLAN (RECIRCULATION LINES ONLY) SCALE 1/4" = 1'

LAKESIDE ENGINEERING P.C. 11 CENTRE PARK, SUITE 305 ROCHESTER, NY 14614 PHONE 585.279.9300 lsengrpc.com **CLIENT:** TOWN OF DELHI, NEW YORK **5 ELM STREET** DELHI, NEW YORK 13753

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| DATE | DESCRIPTION |
|-----------|-------------------------------------|
| 6/15/2017 | POOL INLET SPECIFICATIONS |
| 6/15/2017 | ADD STEPS & HANDRAIL TO WADING POOL |
| | 6/15/2017 |

PROJECT:

TOWN OF DELHI, NEW YORK MUNICIPAL SWIMMING POOL & BATH HOUSE PROJECT


DRAWING TITLE:

SWIMMING POOL PIPING PLAN RECIRCULATION LINES

DRAWING NO: 08/04/17 1/4" = 1'-0" DRAWN BY: S.D./J.X. REVIEWED BY: R.P.

SECTION NO. / SHEET NO.

SPP-1/16 JOB ID: DT016-001

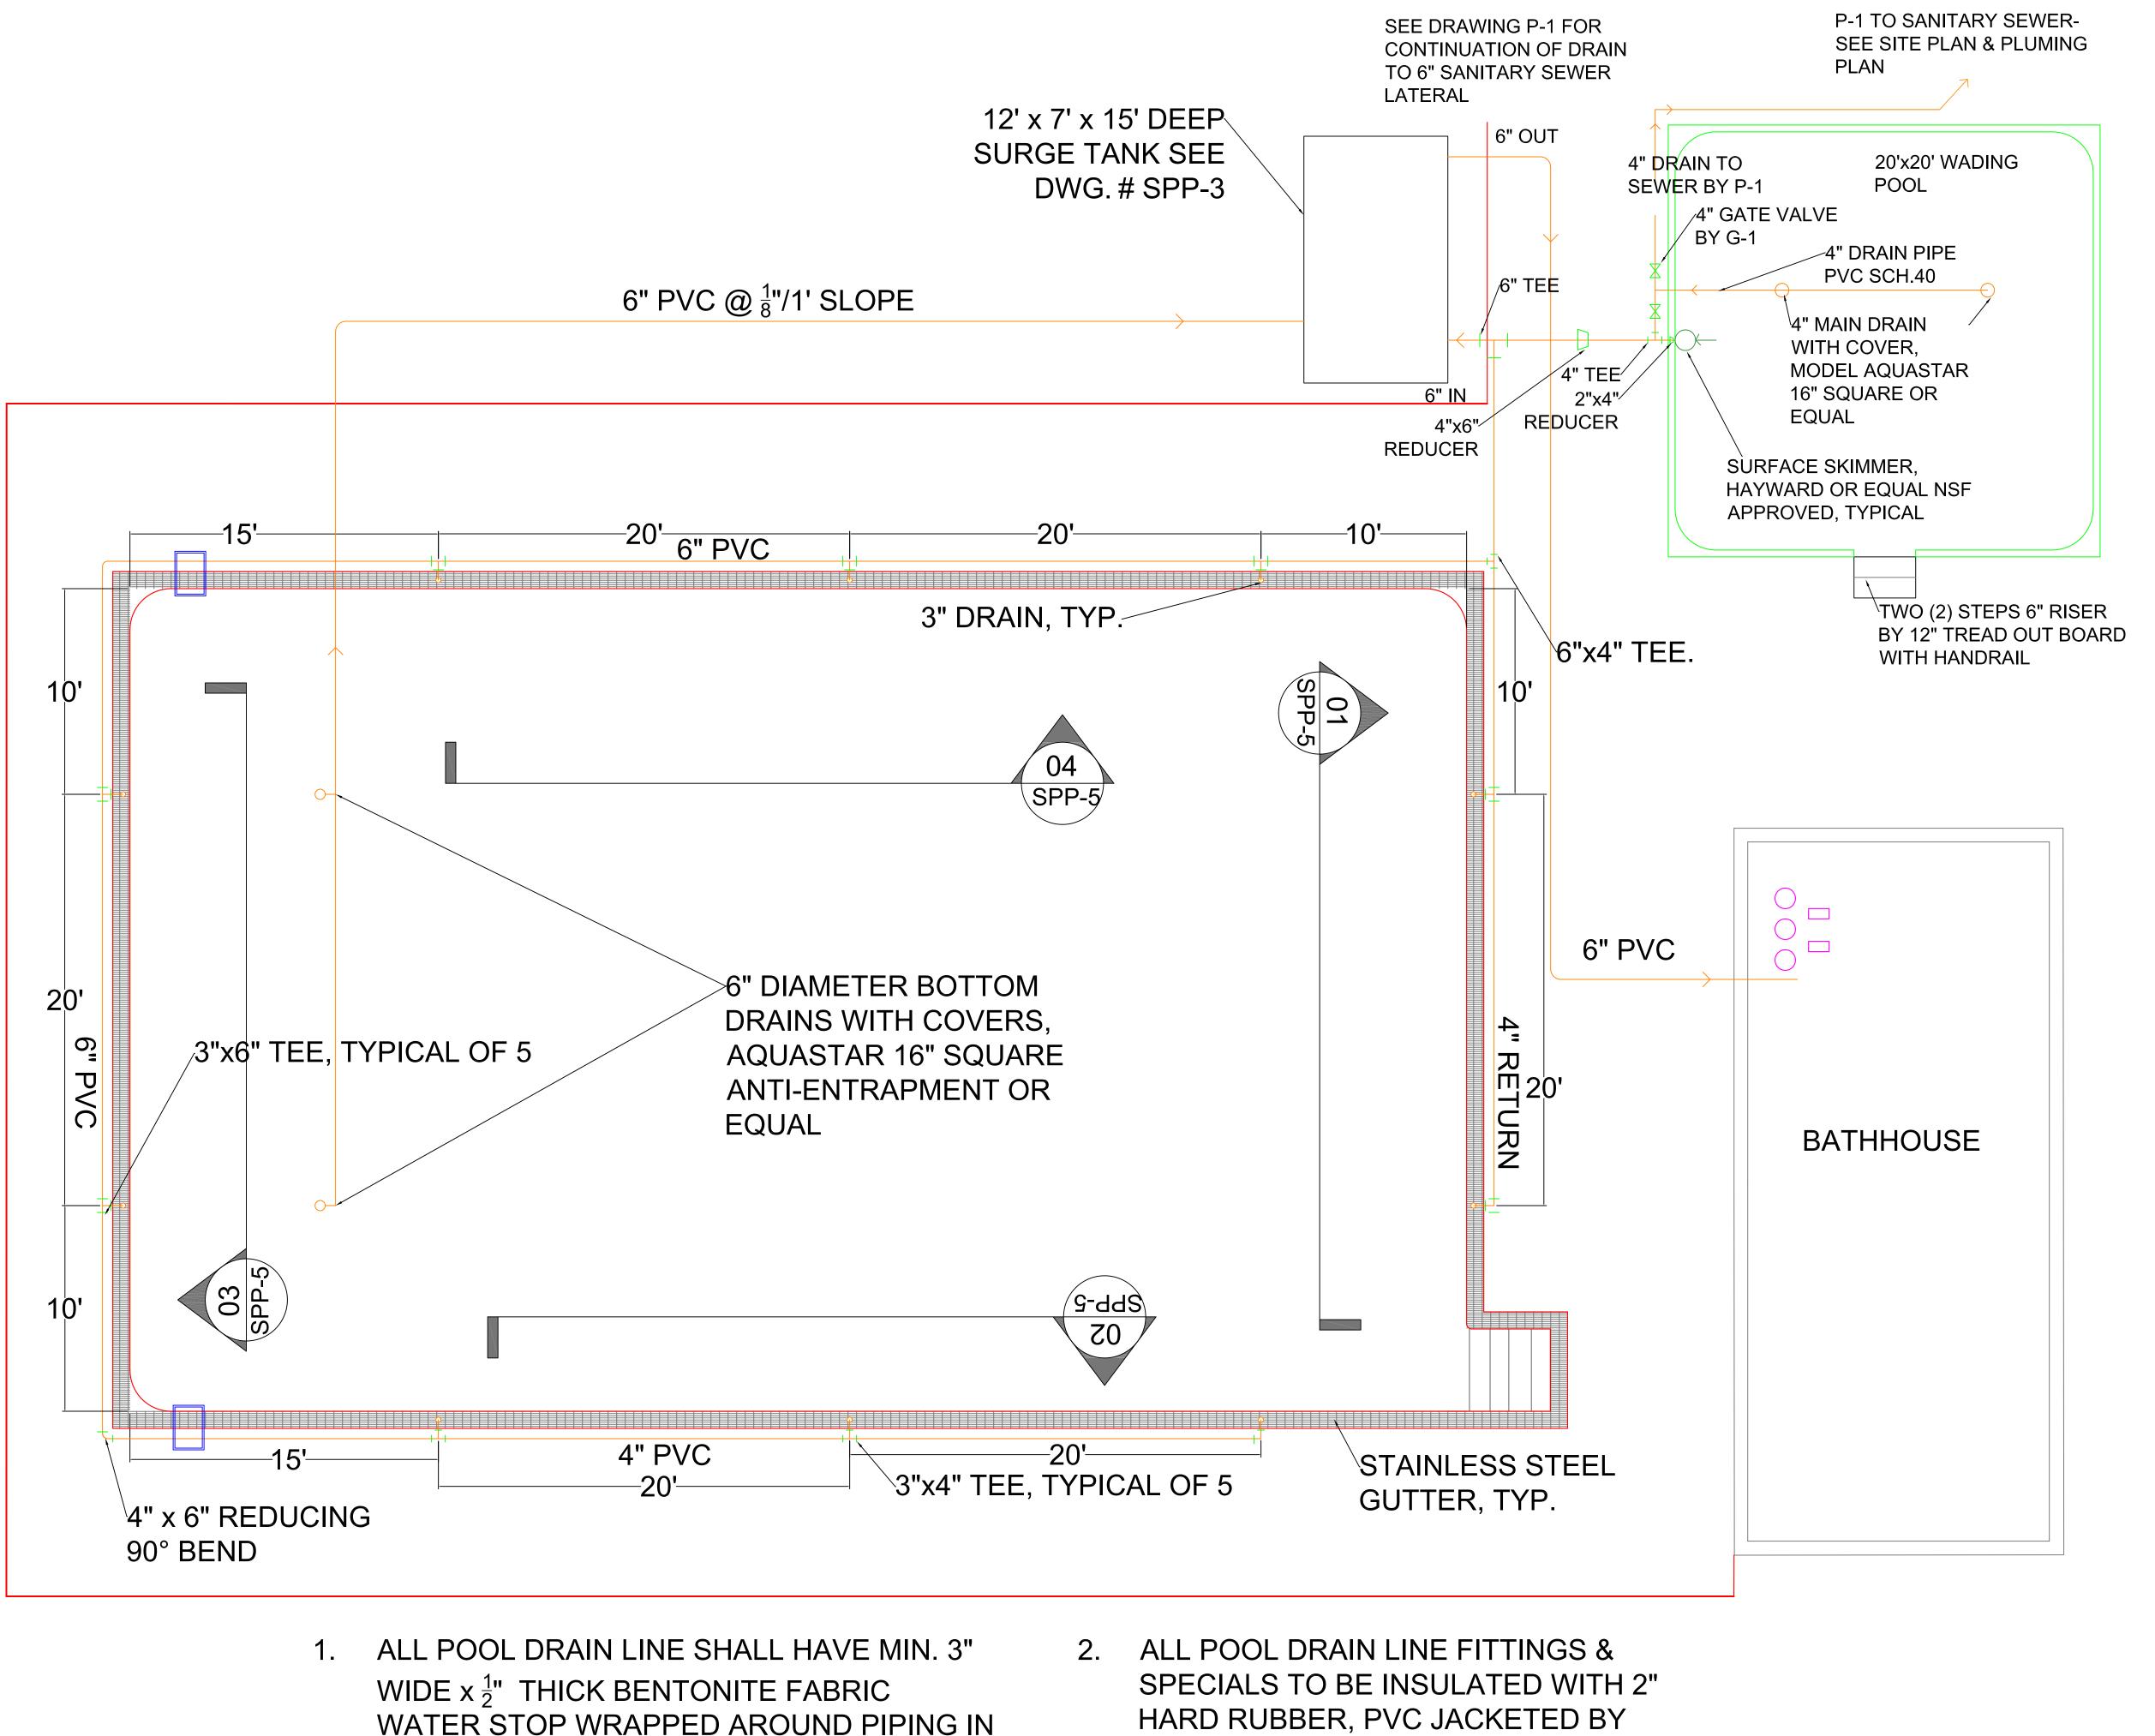

WALL WHETHER OR NOT SHOWN ON

DWGS., BANDED TO PIPE

AEROFLEX USA UNDER RECIRCULATION

PIPING INSULATION ADDER BID.

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| | IS: |
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| DATE | DESCRIPTION |
| 6/15/2017 | MAIN DRAIN COVERS |
| 7/31/2017 | REMOVE SKIMMER |
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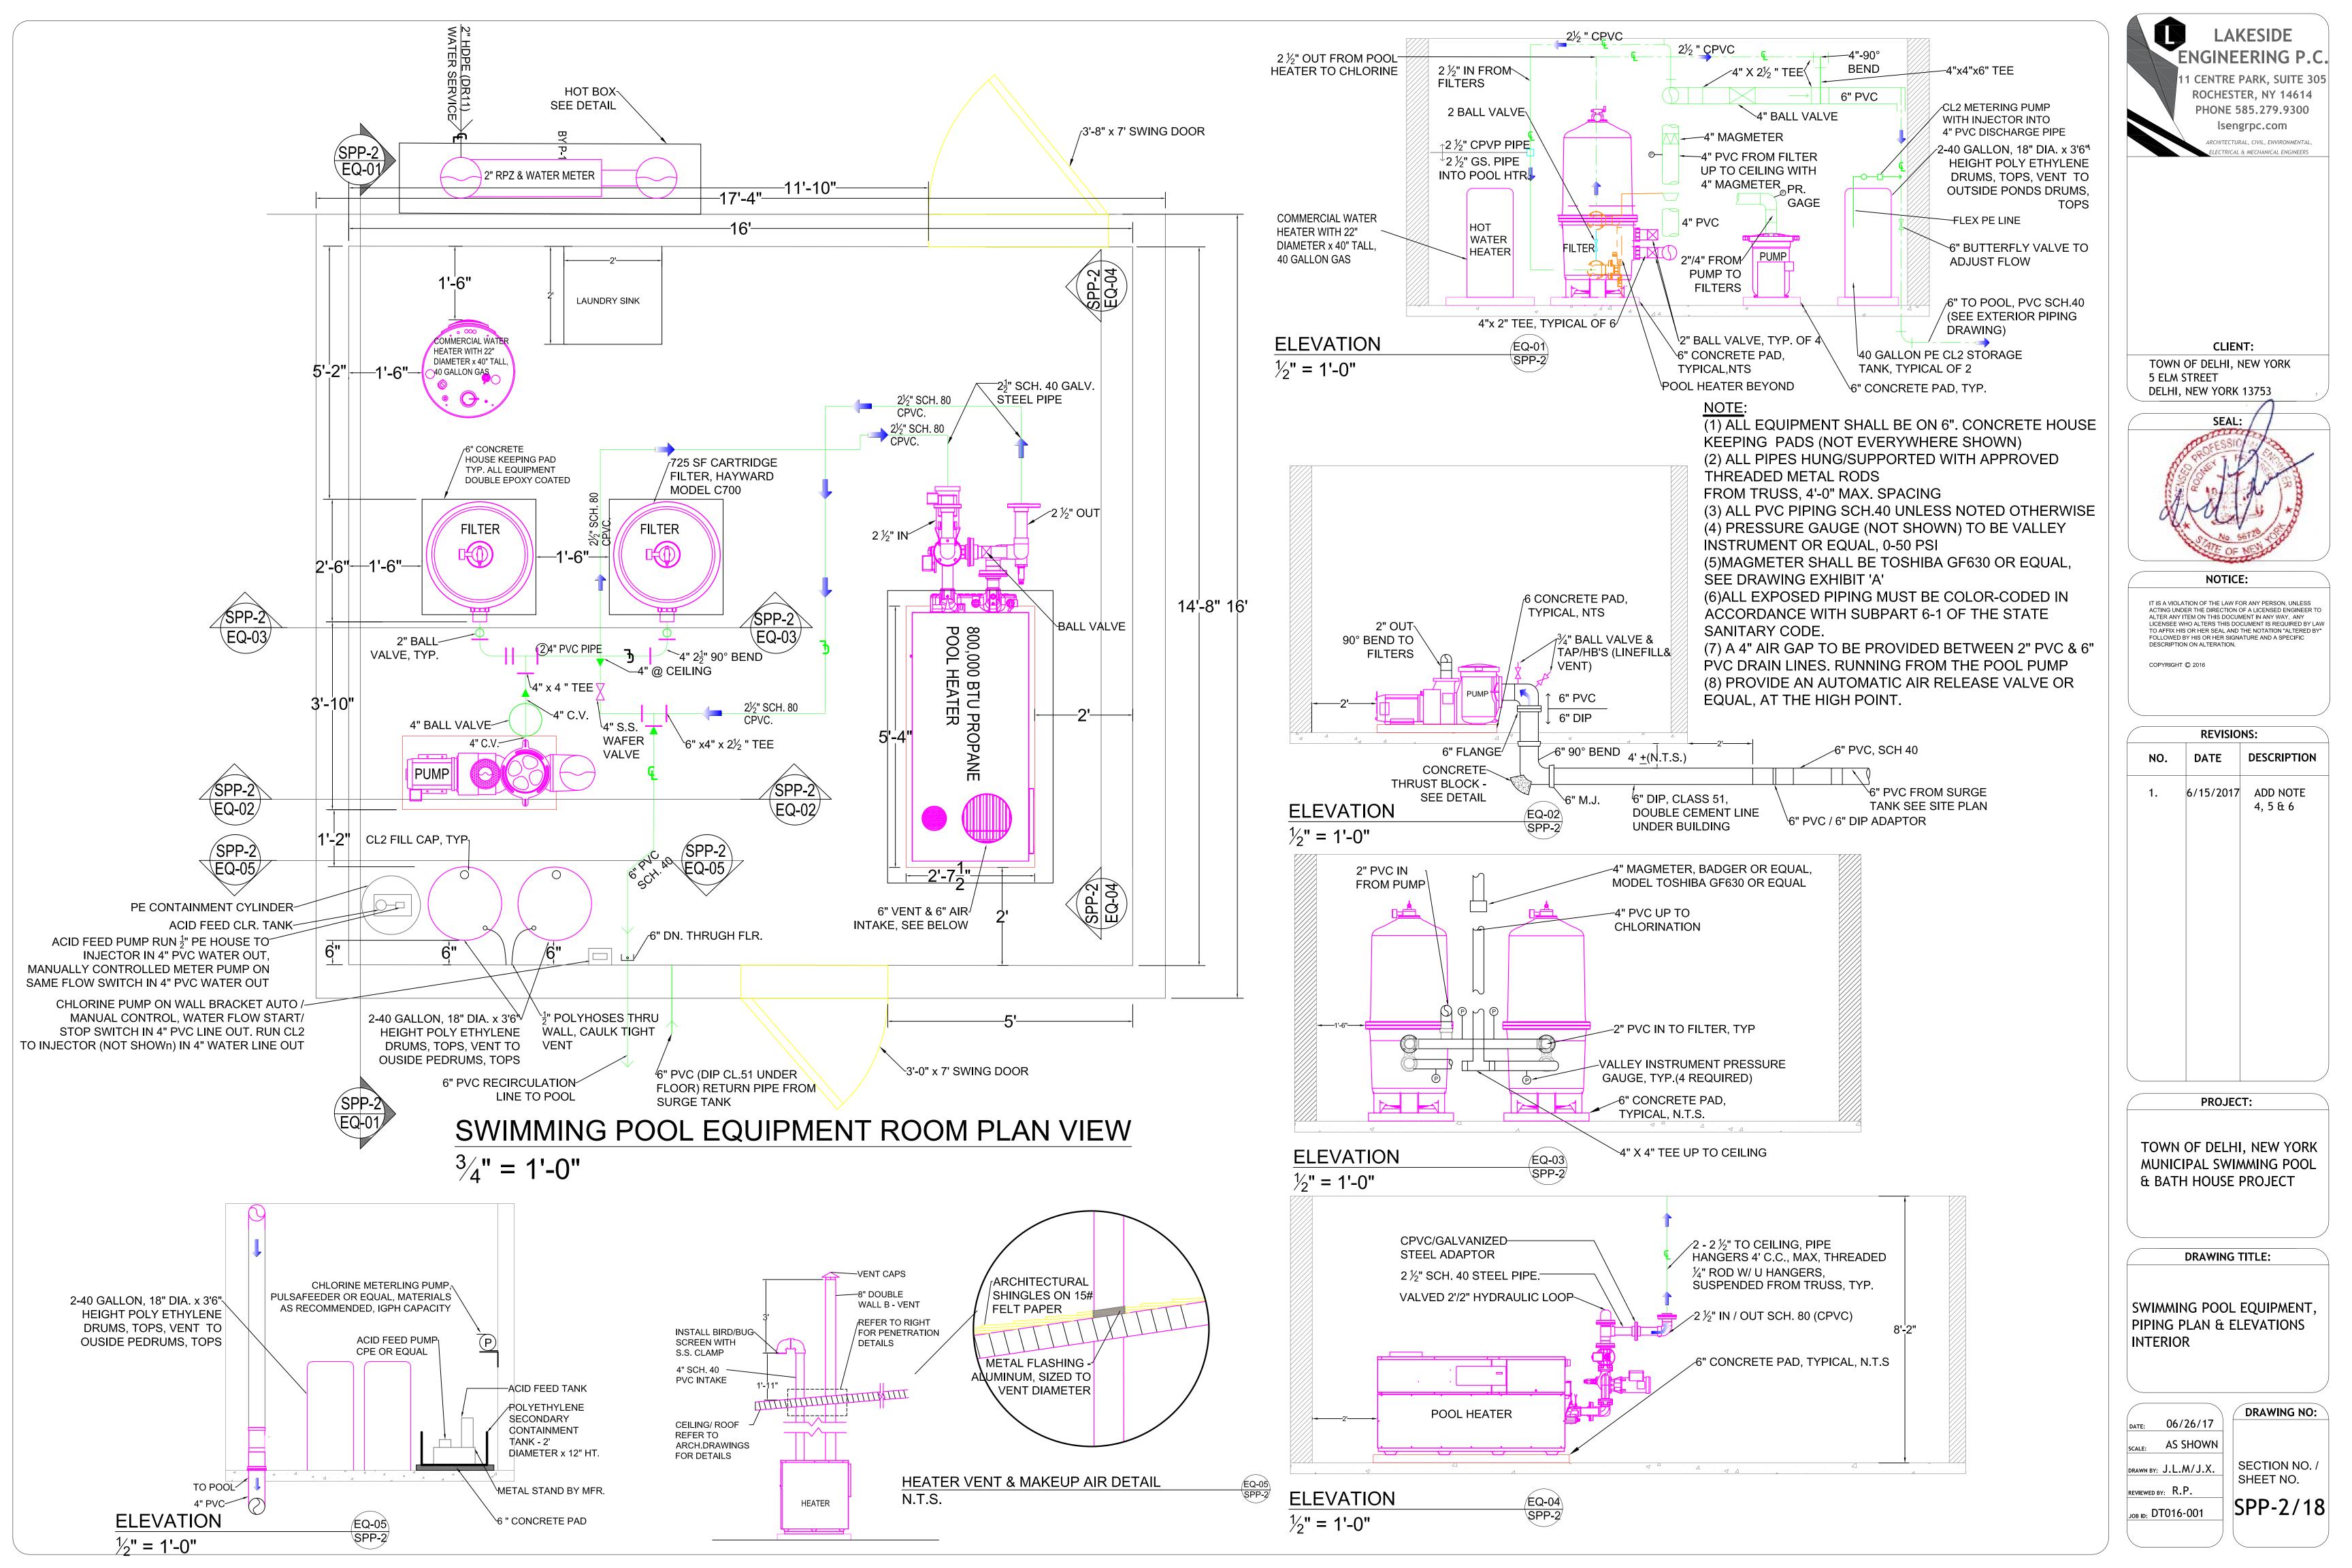
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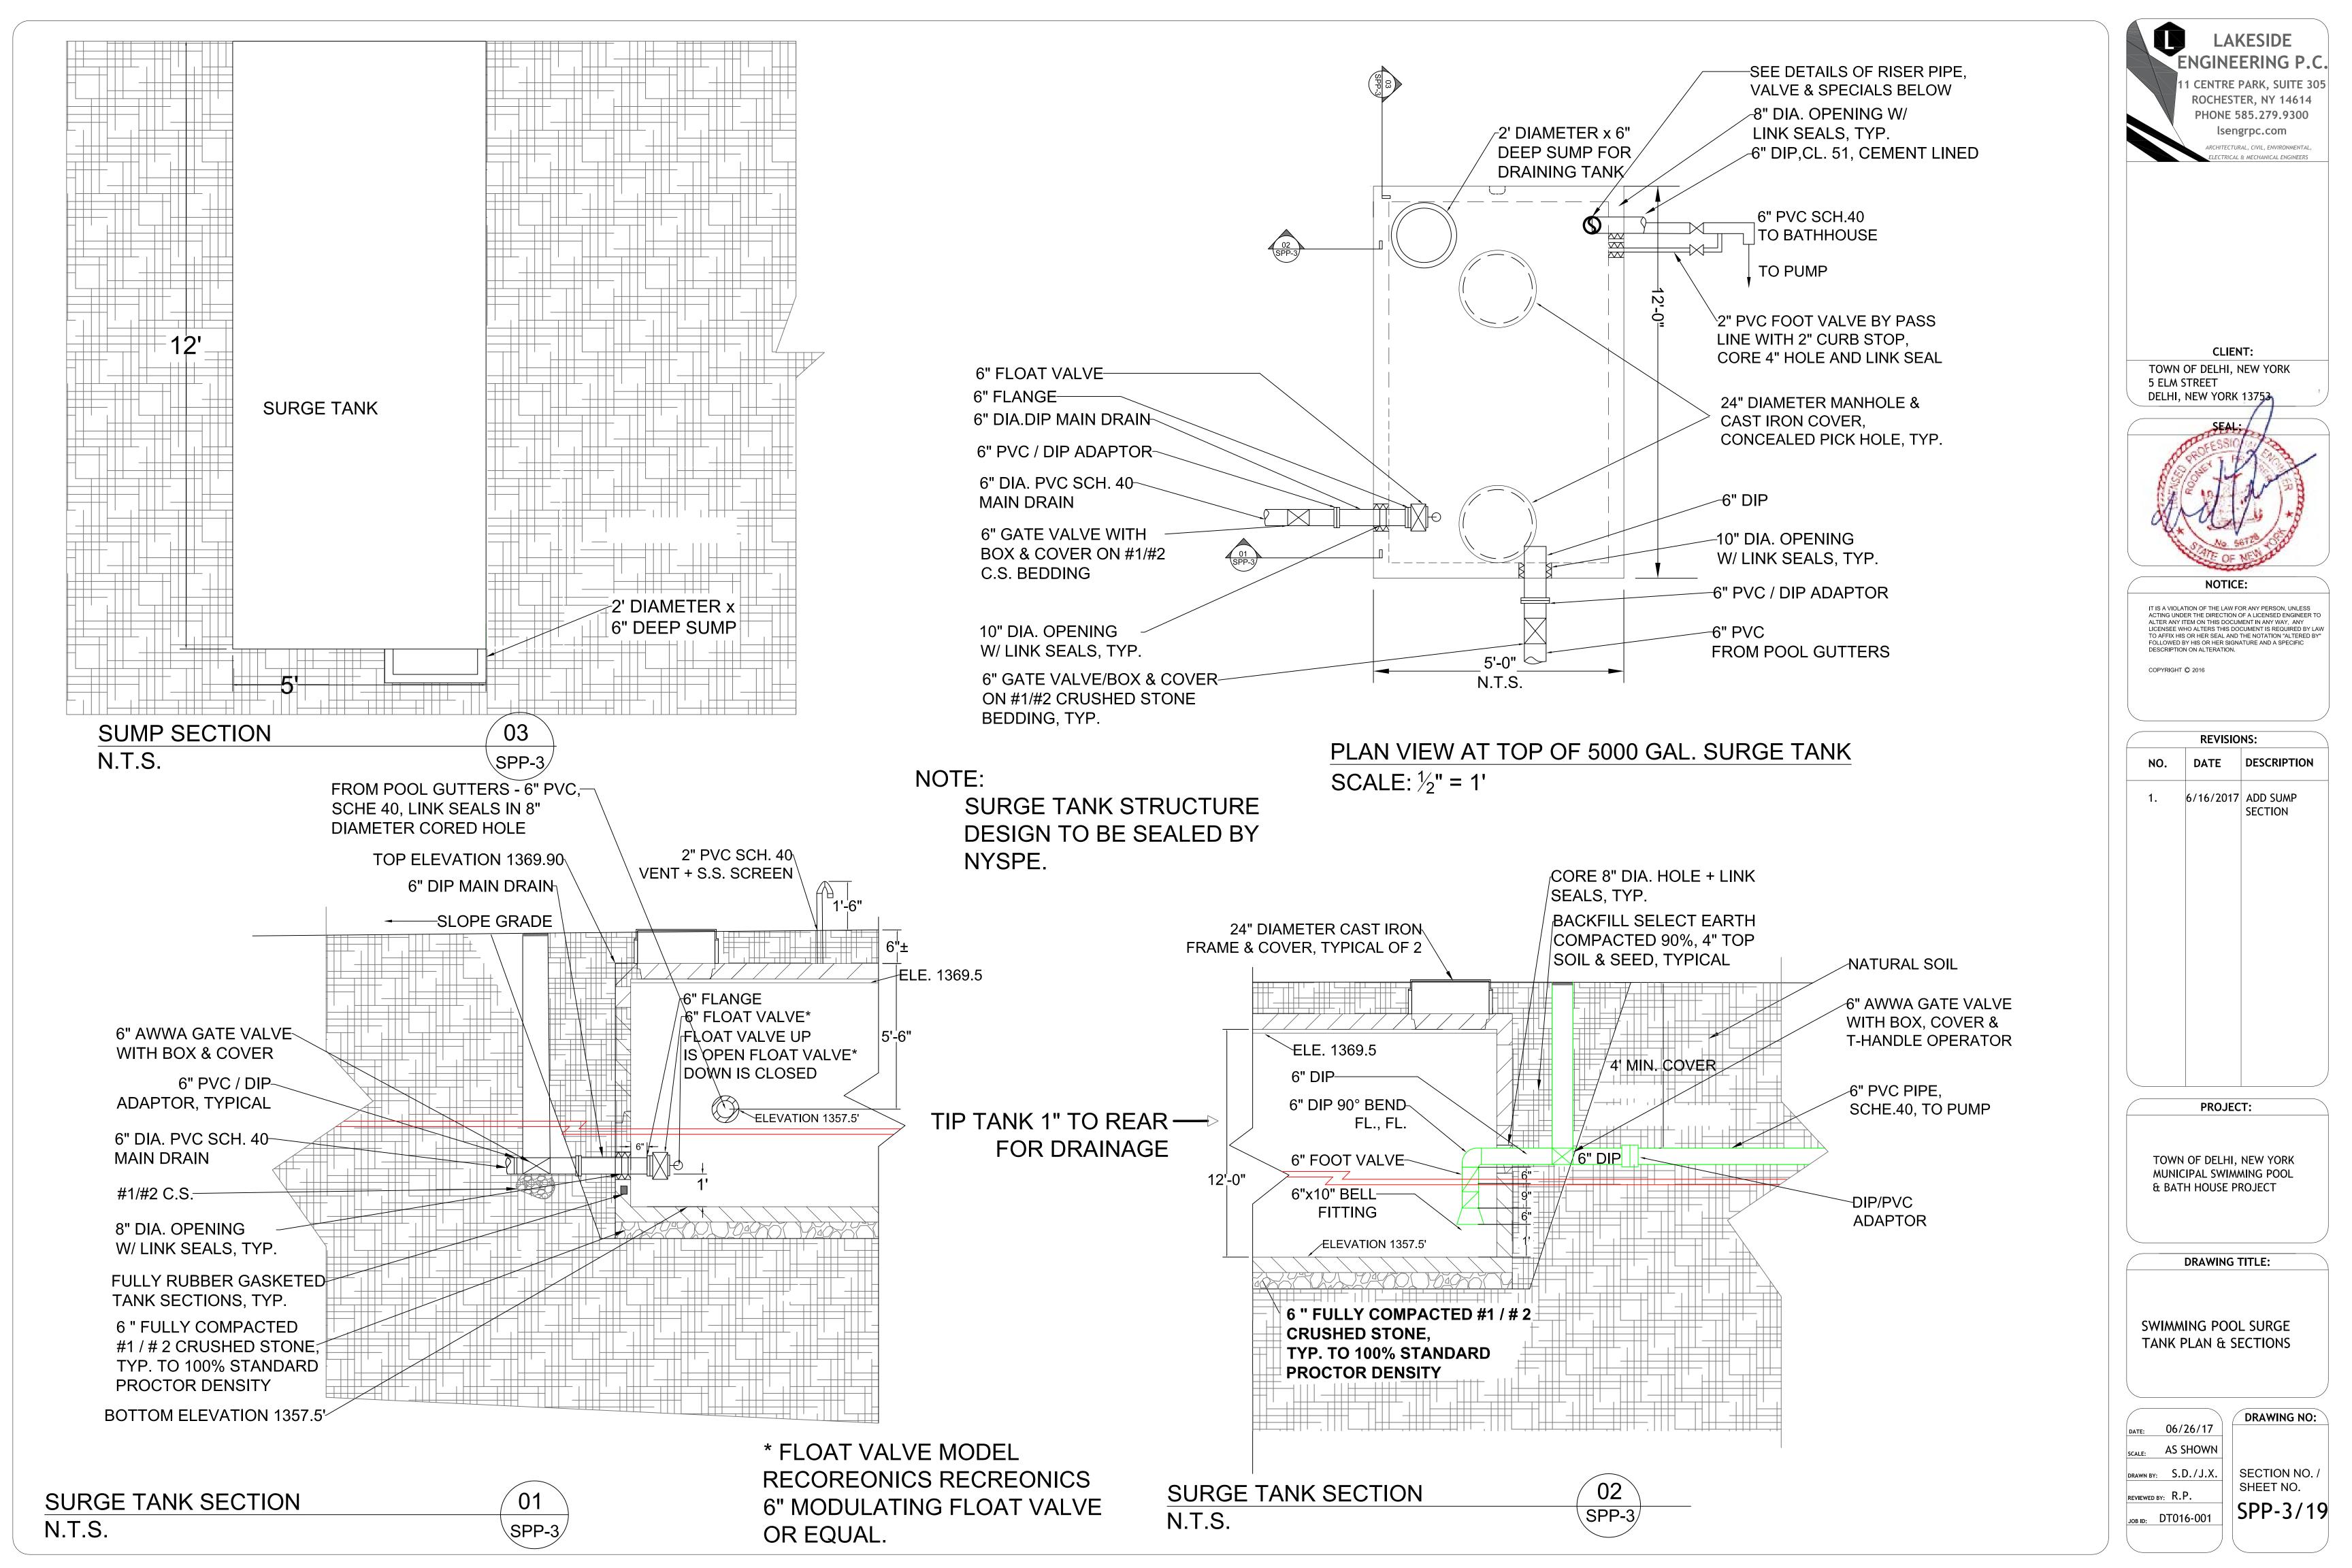
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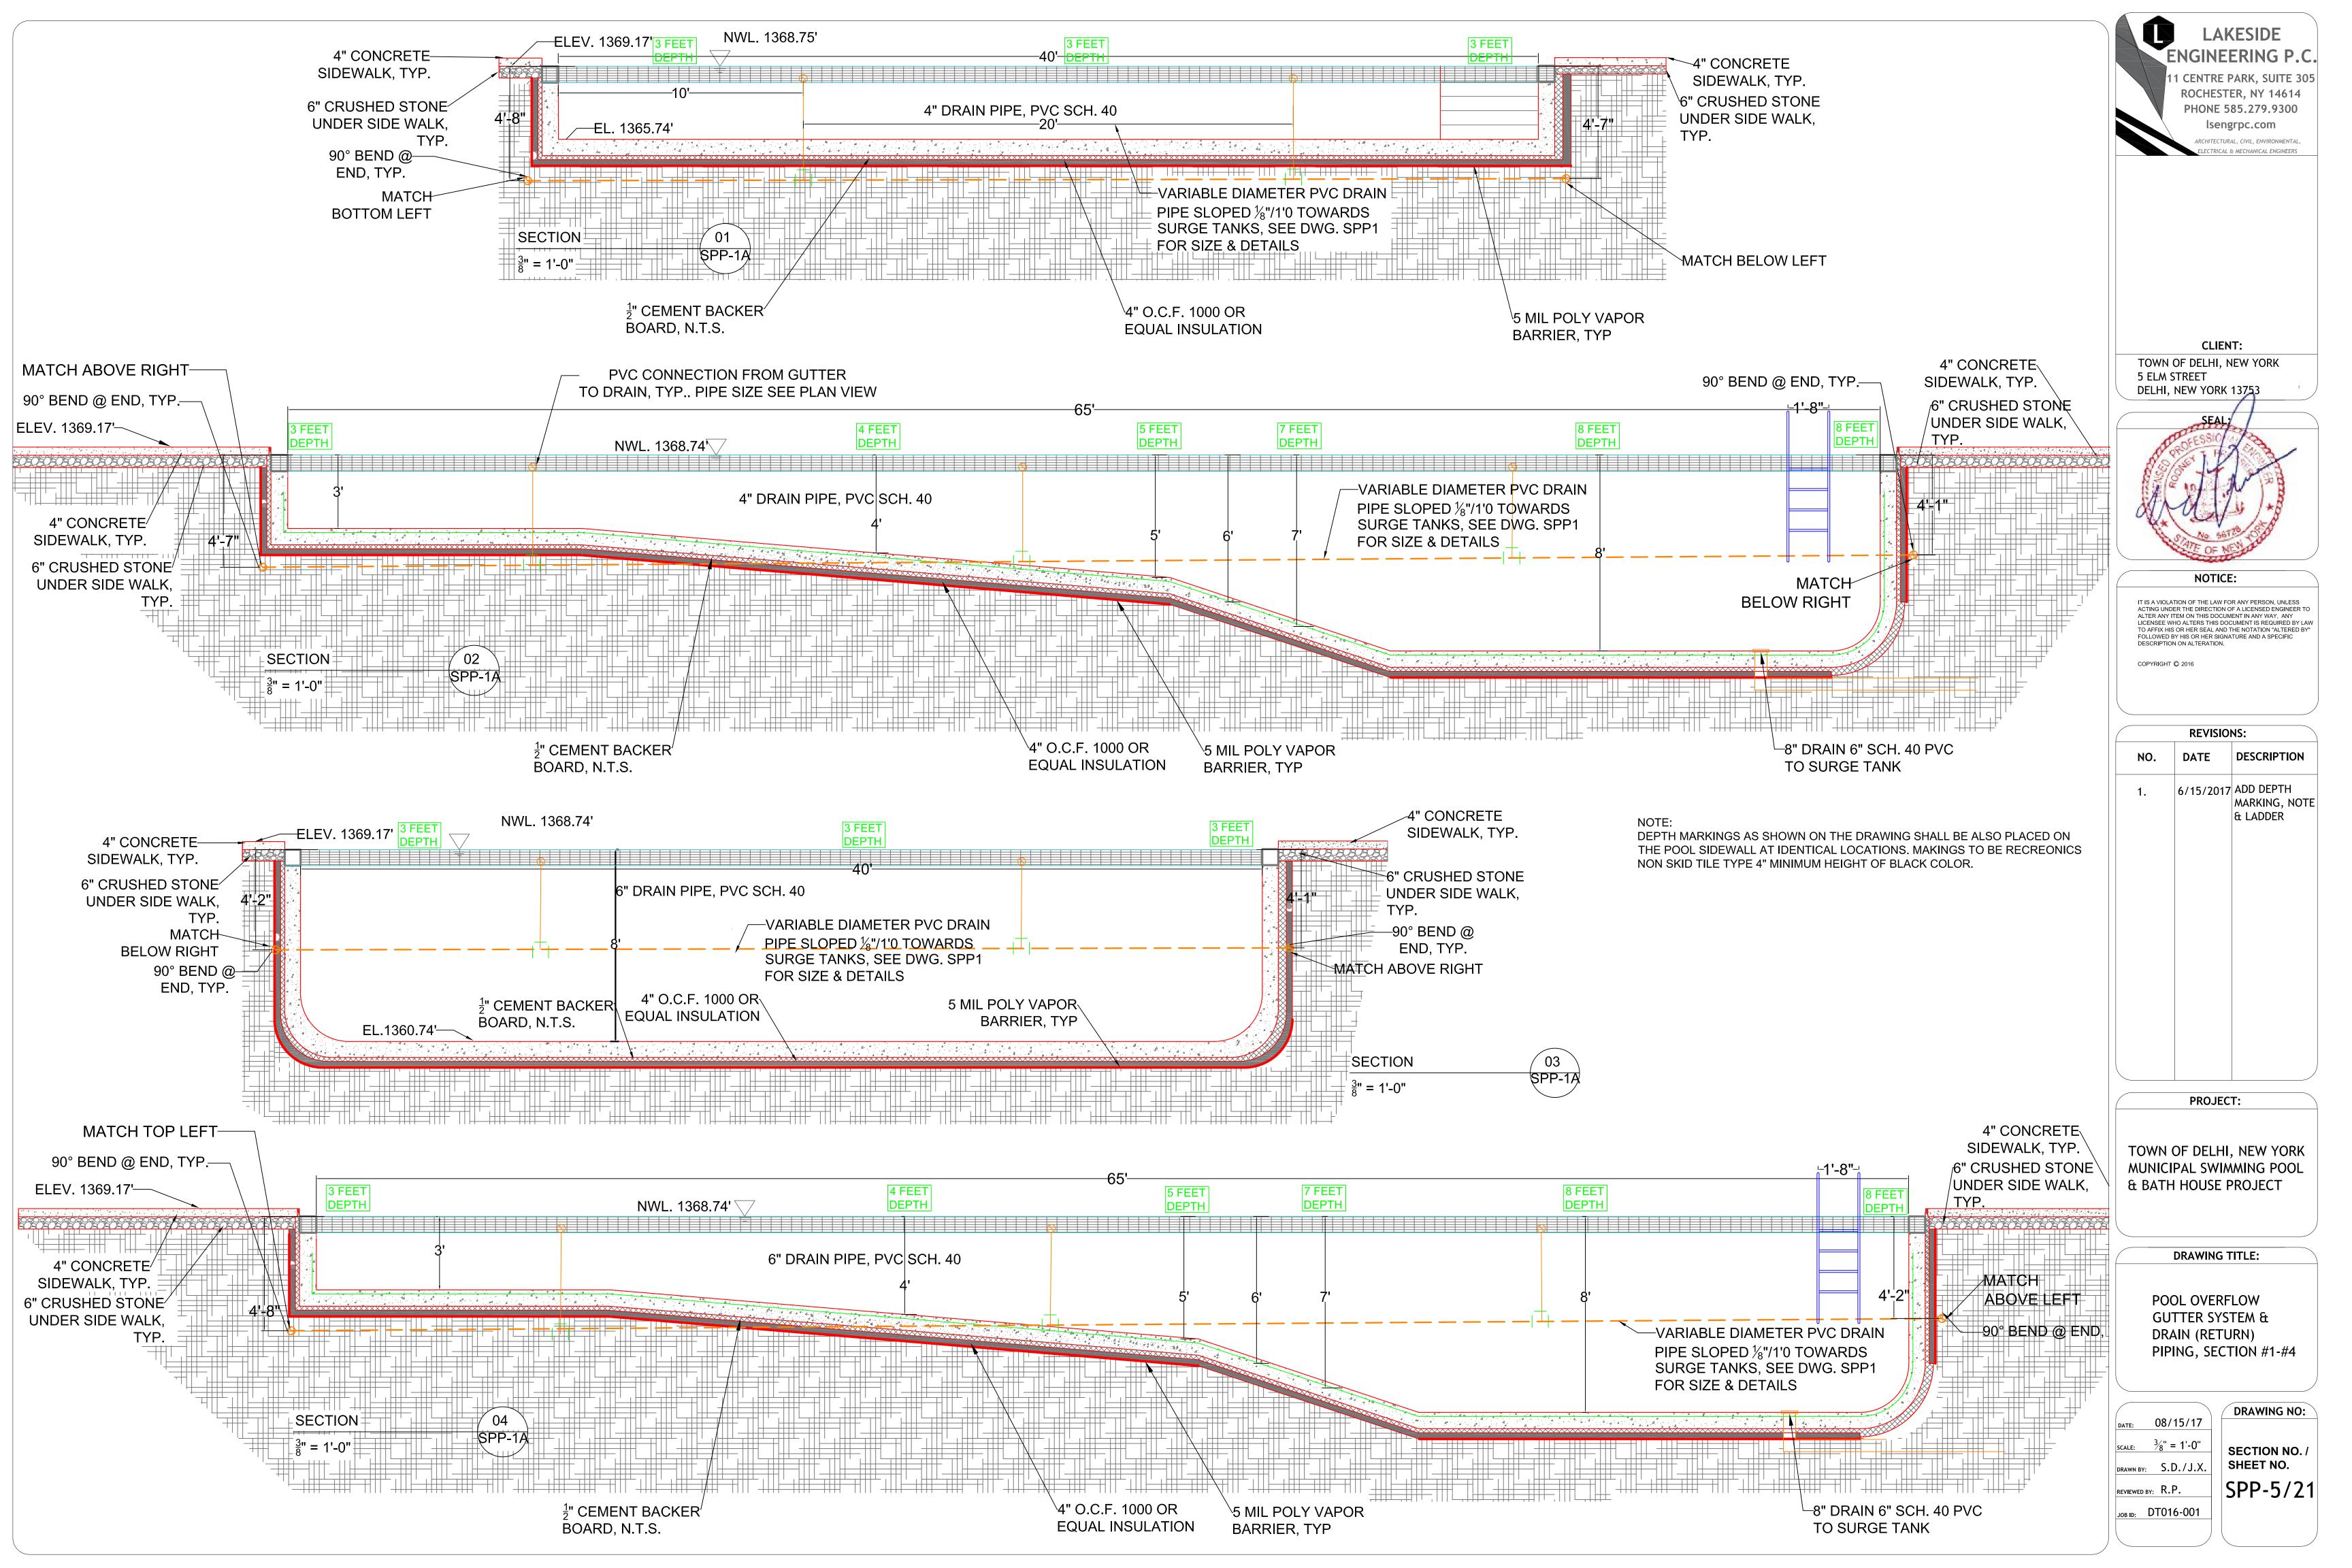
SWIMMING POOL PIPING PLAN DRAIN (RETURN) LINES


SWIMMING POOL PLAN (DRAIN LINES ONLY)
SCALE 1/4" = 1'









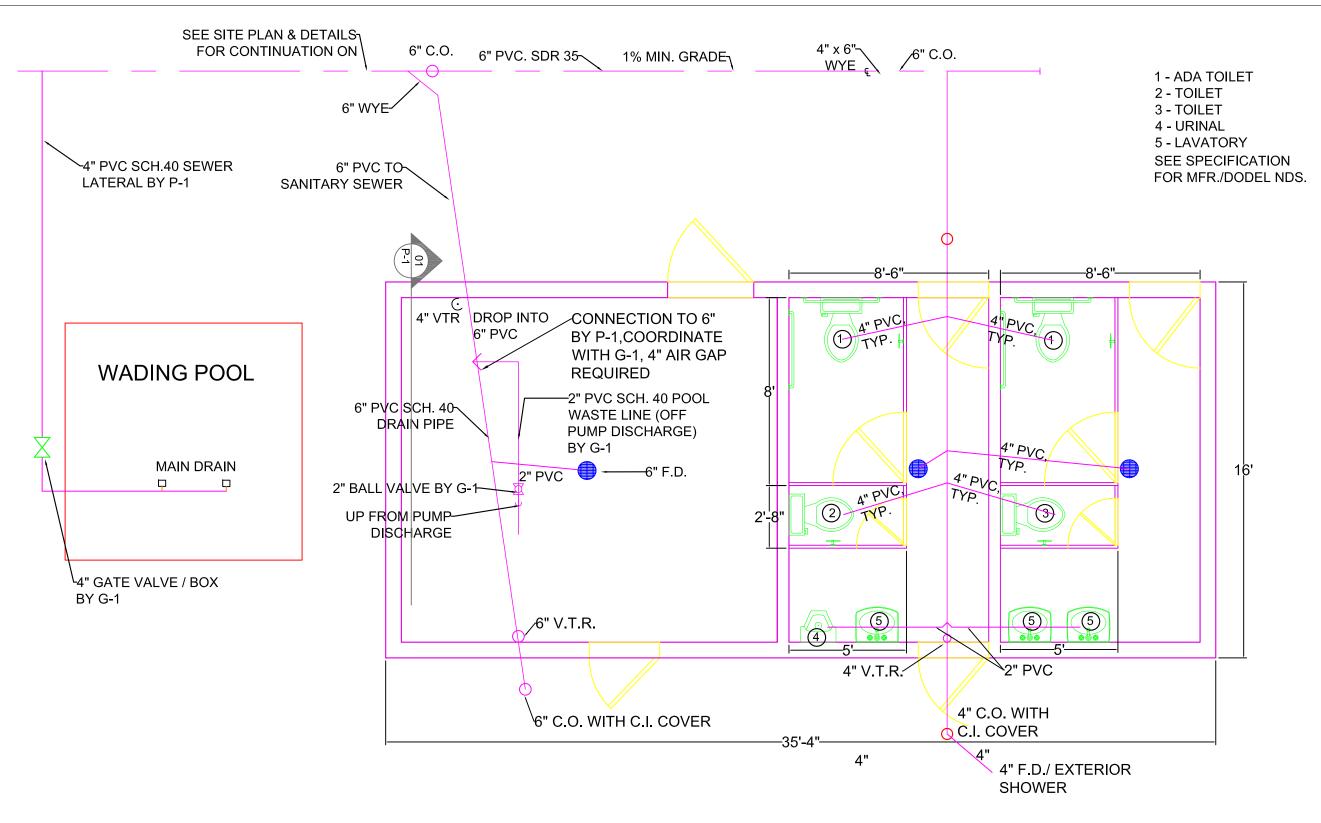

BATHHOUSE SANITARY PIPING

BATHROOM STALLS & ACCESSORIES

HANGER
TYP.

2" PVC SCH. 40 DOWN
FROM PUMP WASTE

REFER TO SPECIFICATIONS, SECTION 15,

FOR DETAILS OF PLUMBING FIXTURES &

POOL PUMP SANITARY LINE DRAWING ELEVATION

N T S

NOTES: 1.) INSTALL 48" x 48" ICE & WATER SHIELD LEAK BARRIER TARGET SHEET

∼6" PVC SAN. LATERAL

FROM FLOOR DRAIN

2.) DO NOT FACE NAIL THE PLUMBING VENT FLASHING

LOWER TRUSS CHORD MANUAL BYPASS VALVE -ADJUSTABLE CLEVIS TYPE GALVANIZED HANGERS @ 2" PVC FROM RPZ DISCHARGEN 4'-0" CC, SUBMIT FOR APPROVAL 4" PVC FROM FILTERS -2" BALL VALVE -2" x 6" TEE BY G-1 CONNECT BY P-1 2" SOLENOID VALVE CLARK-COPPER EH70 OR EQUAL, -4" PVC RETURN TO POOL POWER BY E-1 (MOUNT ON FRONT WALL) 2" BALL VALVE TYP.— 2" WATT, MODEL-007 DCVA BY P-1 4" TO POOL PLUMBING SCHEMATIC -POOL WATER FILL SYSTEM N.T.S. LOCATE ALL FASTENERS WITHIN 1/2" OF THE EDGE OF THE FLASHING LEAK BARRIER


CUT SHINGLES TO FIT AROUND

PRE-FLASHED PLUMBING

VENT FLASHING

FLASHING TO LEAVE A 1/4" CHANNEL

PLUMBING VENT FLASHING DETAIL BY P-1 N.T.S.

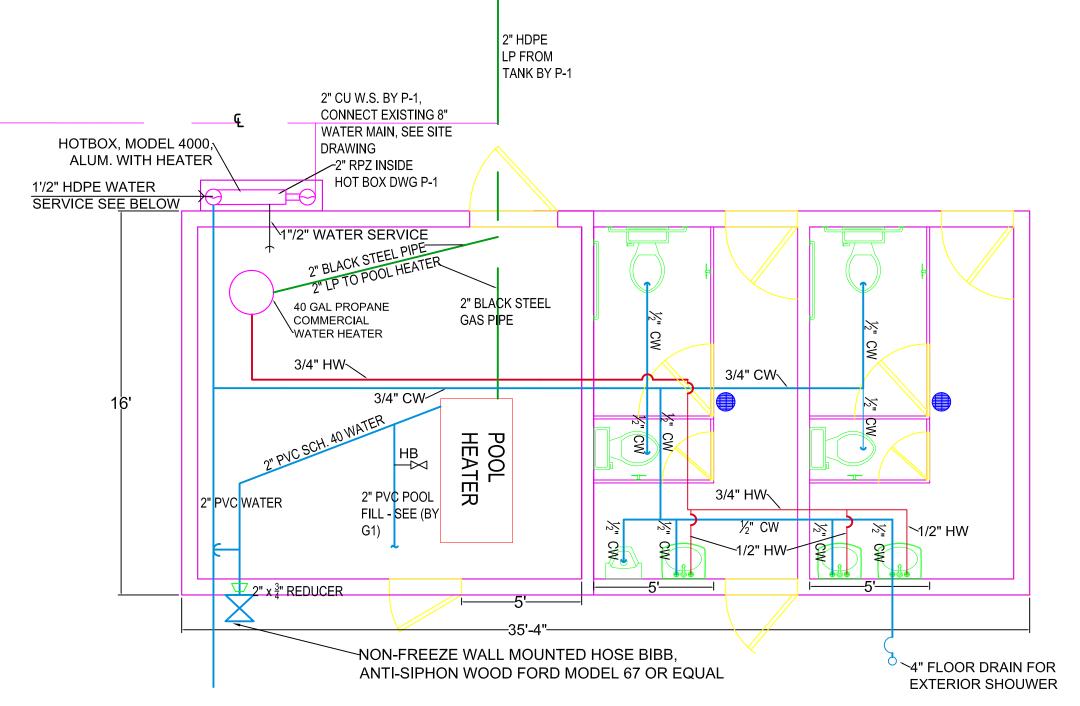

PLUMBING HOT/COLD WATER LINE PLAN @ BATHHOUS

ALL WATER LINES TO BE RUN ON TOP OF LOWER TRUSS CHORD & SHALL BE INSTALLED TO BE EASILY DRAINED INCLUDING AIR INLET VALVES AS NEC. ALL WATER LINES ATTACHED TO WALL INTERIOR; LINES SHALL NOT BE EMBEDDED IN CONCRETE NOR RUN INSIDE MASONRY

GENERAL PLUMBING NOTE:

ALL SEWER PIPING SHALL BE SCH. 40 PVC (INSIDE) & PVC SDR 35 (OUTSIDE) SUBMIT ALL PIPING HANGERS & SPECIALS FOR APPROVAL

ALL HOT & COLD WATER TO BE TYPE "K" OR TYPE "N" COPPER SET UP FOR WINTER BLOW DOWN, PROVIDE HOSE BIBBS AS NEEDED ALONG WATER LINES FOR DRAINING

SEE SITE PLAN FOR CONTINUATION OF GAS & WATER PLUMBING PIPING

RUN WATER PIPING OVERHEAD, SUPPORT ON LOWER TRUSS CHORD, TYP. SUBMIT HANGERS FOR APPROVAL. MAX SPACING 4'0 CC.

REFER TO SITE PLAN DWGS. FOR DETAILS SHOWING REQUIREMENTS FOR UNDERGROUND SANITARY SEWER LATERAL & NEW 2" HDPE, DR11 OR TYPE K COPPER WATER SERVICE INSTALLATION

THE CONTRACTOR SHALL OBTAIN INFORMATION ABOUT THE EXISTING UNDERGROUND UTILITIES FROM LOCAL AUTHORITY (DELHI) RECORDS AND SHALL DETERMINE THE EXACT LOCATION AND ELEVATION OF EXISTING UTILITIES BY FIELD INVESTIGATION.

THE CONTRACTOR SHALL OBTAIN PERMITS FROM ALL FEDERAL, STATE, AND/OR LOCAL PERMIT AUTHORITY HAVING JURISDICTION OVER ANY PHASE OF CONSTRUCTION ASSOCIATED WITH THE INSTALLATION OF THIS SYSTEM.

THE CONTRACTOR SHALL MAINTAIN THE CONSTRUCTION SITE IN A NON-HAZARDOUS CONDITION ALL IN ACCORDANCE WITH THE REQUIREMENTS OF THE NEW YORK STATE DEPARTMENT OF LABOR, OSHA, AND ALL OTHER AGENCIES HAVING JURISDICTION. UNLESS OTHERWISE APPROVED IN WRITING (BY DELHI), THE CONTRACTOR SHALL ERECT AND MAINTAIN ADEQUATE

THE CONTRACTOR SHALL CHECK THE LOCATION, ELEVATIONS, INVERTS, POSITIONS, AND SIZES OF ALL CONNECTIONS ON THE EXISTING HYDRANT WHERE A 2-1/2" DIAMETER WATER SUPPLY CONNECTION TO THE BATH HOUSE IS TO BE MADE. PROVIDE ISOLATION

FENCING AROUND ALL OPEN EXCAVATIONS.

VALVE (LOCKED OPEN) AT THE HYDRANT.


THE CONTRACTOR SHALL PROVIDE EXCAVATION FROM THE HYDRANT CONNECTION TO THE BATH HOUSE.


THE CONTRACTOR SHALL INSTALL 2" DIAMETER UNDERGROUND PIPING FROM THE UTILITY TO THE BATH HOUSE INCLUDING WALL PENETRATION INTO THE BATH HOUSE AT THE FILTER ROOM. THE INSTALLATION SHALL COMPLY WITH AWWA STANDARDS. CONNECTION TO THE HYDRANT SHALL BE MADE AT HOURS TO BE DETERMINED BY THE LOCAL AUTHORITIES. THE LOCAL AUTHORITY IS VILLAGE OF DELHI, P. O. BOX 328, DELHI, NY 13753, ATTENTION: MR. DAVID CURLEY, SUPERINTENDENT OF PUBLIC WORKS.


THE CONTRACTOR SHALL INSTALL WATER METER AND ISOLATION VALVES, AND RPZ VALVE AS MANUFACTURED BY WATTS, MODEL 909QT SERIES IN THE FILTER ROOM.


WATER SUPPLY PIPING SHALL BE INSPECTED, TESTED AND APPROVED BEFORE BACK FILLING. CONTRACTOR TO LOCATE AND REMEDY ALL DEFECTS FOUND DURING TESTING AND SHALL REPEAT THE TEST AT NO COST TO OWNER UNTIL THE INSTALLATION IS ACCEPTED.

REFER TO SITE DRWGS. FOR CONTINUATION & DETAIL

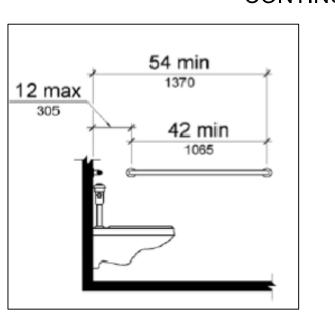


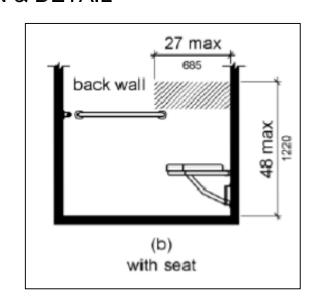

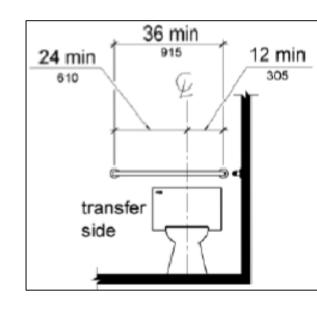

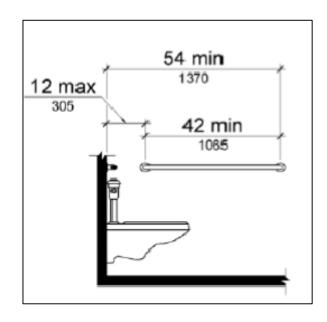


HANDICAPPED BATHROOM STALL

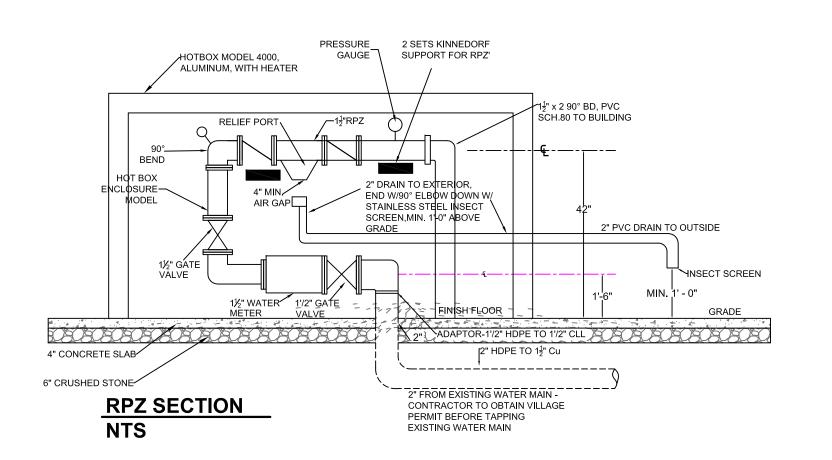



CLIENT:
TOWN OF DELHI, NEW YORK
5 ELM STREET

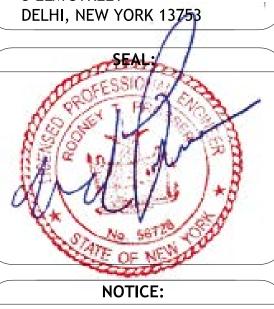

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REVISIONS:

NO. DATE DESCRIPTION

1. 6/15/2017 HOSE BIBE

TOWN OF DELHI, NEW YORK MUNICIPAL SWIMMING POOL & BATH HOUSE PROJECT

PROJECT:

DRAWING TITLE:

BATH HOUSE WATER LINES, PLUMBING, FIXTURES, POOL FILL SYSTEM, & DRAIN SYSTEM

DRAWING NO:

DRAWING NO:

DRAWING NO:


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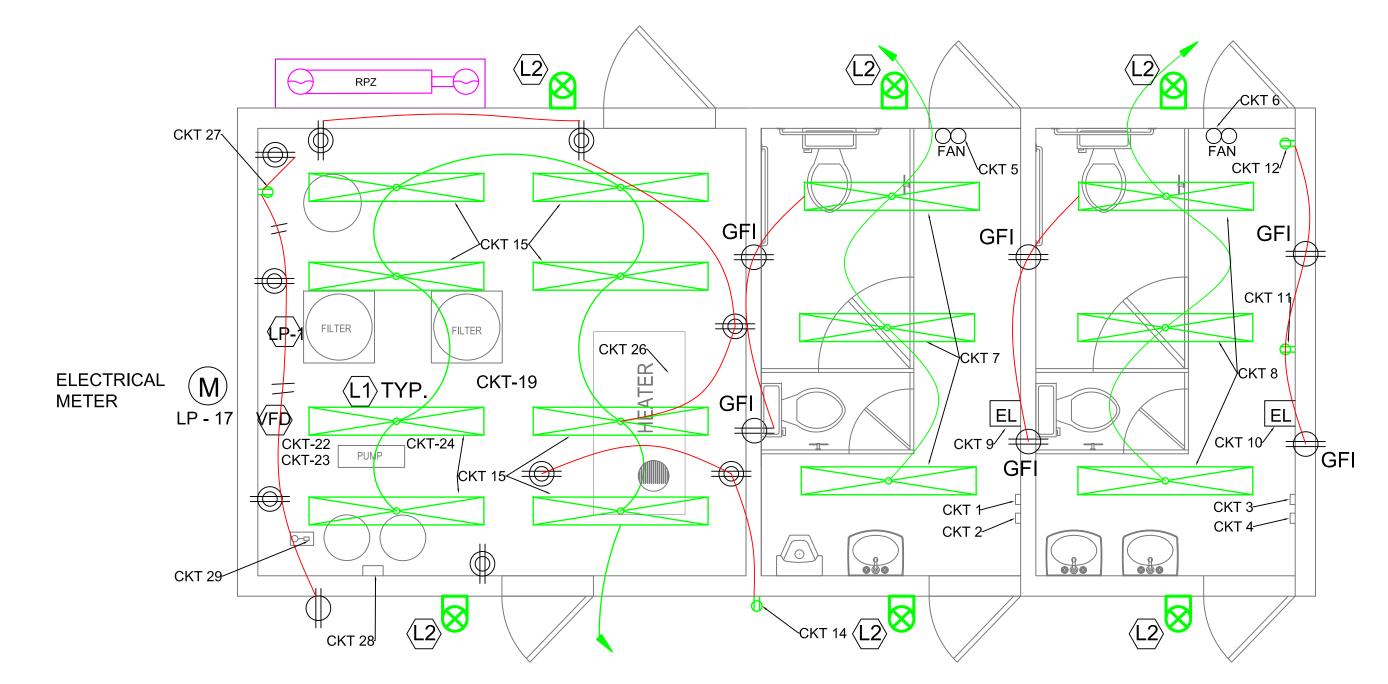
SCALE: N.T.S.

DRAWING NO:

SECTION NO. /
SHEET NO.

P-1/22



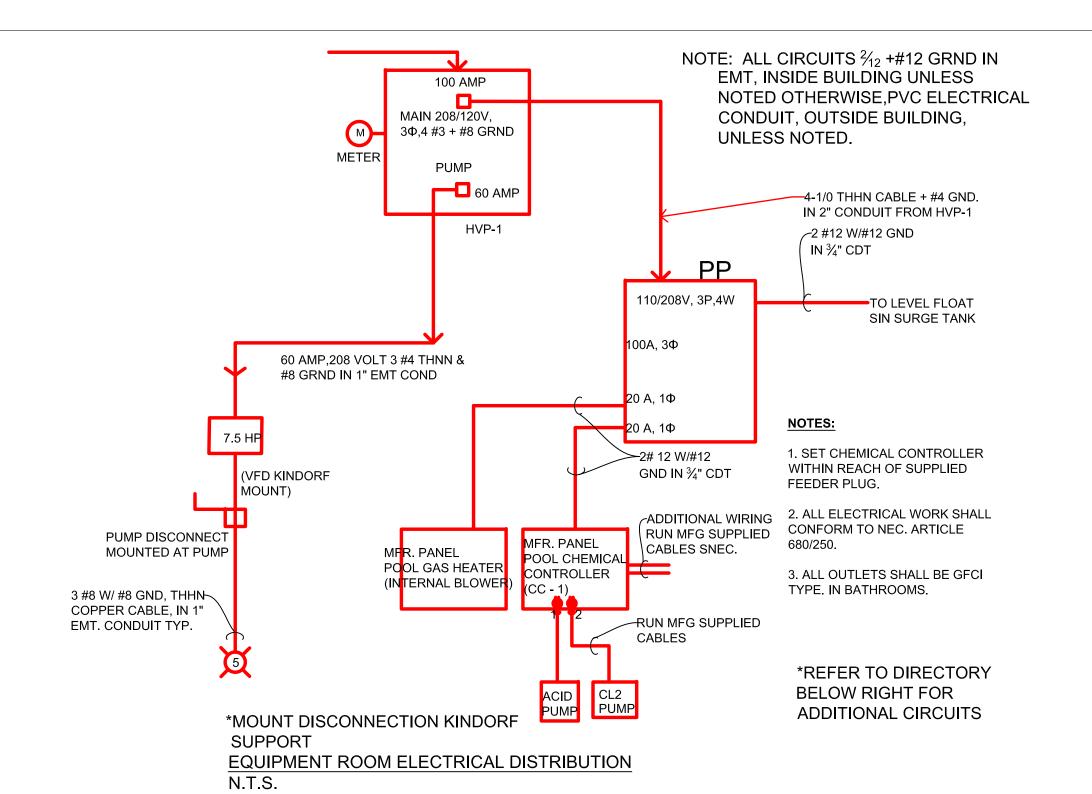


BUILDING LIGHTING & EL. DISTRIBUTION PLAN N.T.S.


| ELECTRIC DISTRIBUTION PANEL | | | | | |
|-----------------------------|------|---------------------------|-------------|---|--|
| NO. | QTY. | CAT. NO. | LABEL | DESCRIPTION | |
| (L1) | 14 | | LED LIGHT | VAPOR TYGHT 4 $\frac{5}{16}$ " WIDE x 47 $\frac{3}{16}$ " LT. ECONOLITE E-VW4L04UCW, 48 WATT, TRUSS MOUNTED | |
| Ľ(P-1) | 1 | SQUARE D NQOD442L225CU | POWER PANEL | DISTR. PANEL, 120/240V P CLASS 1630 NEMA1 ENCL, MAINS RATING: 100 AMPS | |
| (L2) | 6 | | LED | LED BUILDING MOUNTED WALL PACK ON PHOTO CELL | |

EL EN


EMERGENCY LITING

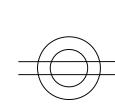

= DUPLEX ELECTRICAL RECEPTACLE

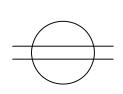

= GROUND FAULT INTERRUPT (GFI) CIRCUIT

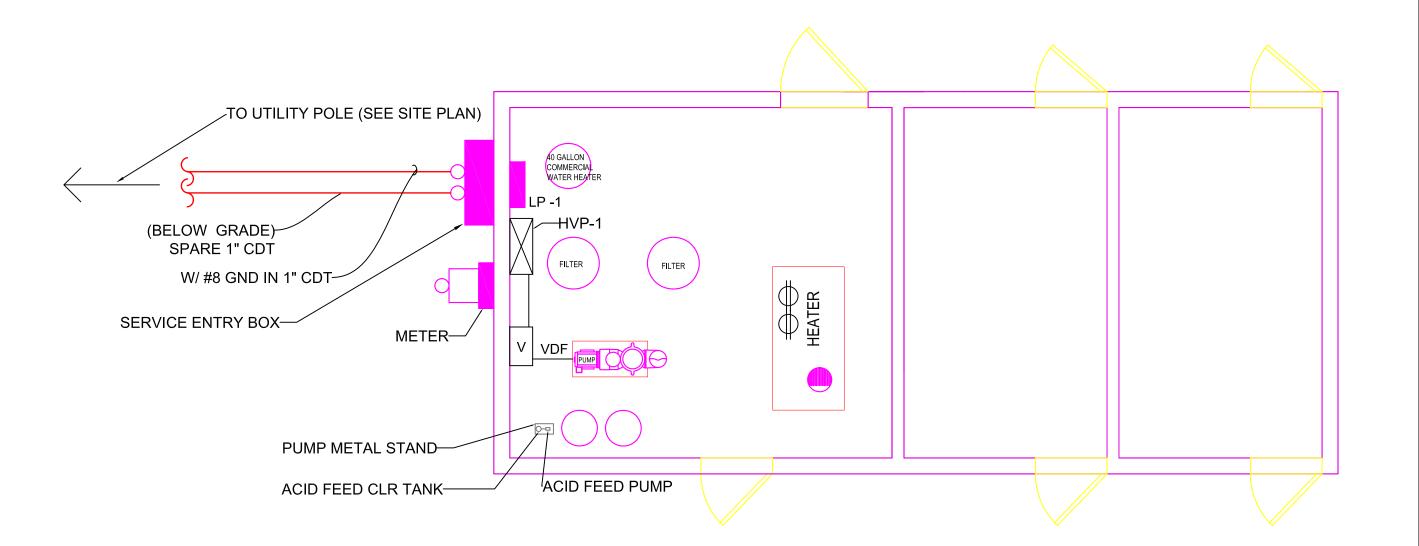

ELECTRICAL POWER PLAN

| LOCATION BUILDING FEEDER SIZE | | EQUIPMENT ROOM | | | |
|---------------------------------|------------|--|-------------------------------|------------|---------|
| | | BATH HOUSE - DELHI, NY 3 # 3 THHN, W/#8 GND IN 2" CDT. | | | |
| | | | | | |
| CKT NO. | TRIP. AMPS | DESCRIPTION OF LOAD | DESCRIPTION OF LOAD | TRIP. AMPS | CKT. NO |
| 1 | 20 | WOMEN BRADLEY HAND DRYER | VFD | 20 | 22 |
| 2 | 20 | WOMEN BRADLEY HAND DRYER | VFD | 20 | 23 |
| 3 | 20 | MEN BRADLEY HAND DRYER | PUMP | 20 | 24 |
| 4 | 20 | MEN BRADLEY HAND DRYER | SPARE | 20 | 25 |
| 5 | 20 | PUBLIC BATHROOM FANS (WOMEN) | POOL HEATER | 20 | 26 |
| 6 | 20 | PUBLIC BATHROOM FANS (MEN) | EQUIPMENT ROOM RECEPTACLE | 20 | 27 |
| 7 | 20 | MAN BATHROOM LED LIGHTING | EQUIPMENT ROOM CL2 METER PUMP | 20 | 28 |
| 8 | 20 | WOMAN BATHROOM LED LIGHTING | EQUIPMENT ROOM ACID PUMP | 20 | 29 |
| 9 | 20 | WOMEN BATHROOM EMERGENCY LITING | SPARE | 20 | 30 |
| 10 | 20 | MEN BATHROOM EMERGENCY LITING | SPARE | 20 | 31 |
| 11 | 20 | BATHROOM RECEPTACLE | SPARE | 20 | 32 |
| 12 | 20 | BATHROOM RECEPTACLE | SPARE | 20 | 33 |
| 13 | 20 | SPARE | SPARE | 20 | 34 |
| 14 | 20 | BUILDING MOUNTED OUTSIDE RECEPTACLE | BLANK | _ | 35 |
| 15 | 20 | EQUIPMENT ROOM LED LIGHTING | BLANK | _ | 36 |
| 16 | 20 | SPARE | BLANK | _ | 37 |
| 17 | 20 | BLANK | BLANK | _ | 38 |
| 18 | 20 | BLANK | BLANK | _ | 39 |



CLIENT:

TOWN OF DELHI, NEW YORK 5 ELM STREET DELHI, NEW YORK 13753



NOTICE:

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PROJECT:

TOWN OF DELHI, NEW YORK MUNICIPAL SWIMMING POOL & BATH HOUSE PROJECT

DRAWING TITLE:

BUILDING MAIN POWER, EQUIPMENT ROOM ELECTRICAL DIST., BUILDING LIGHTING PLAN & ELE. DIST PANEL LP-1 DIRECTORY

DATE: 06/26/17

SCALE: N.T.S.

DRAWN BY: J.L.M/J.X.


DRAWN BY: J.L.M/J.X.

REVIEWED BY: R.P.

JOB ID: DT016-001

SECTION NO. / SHEET NO.

E-1/23

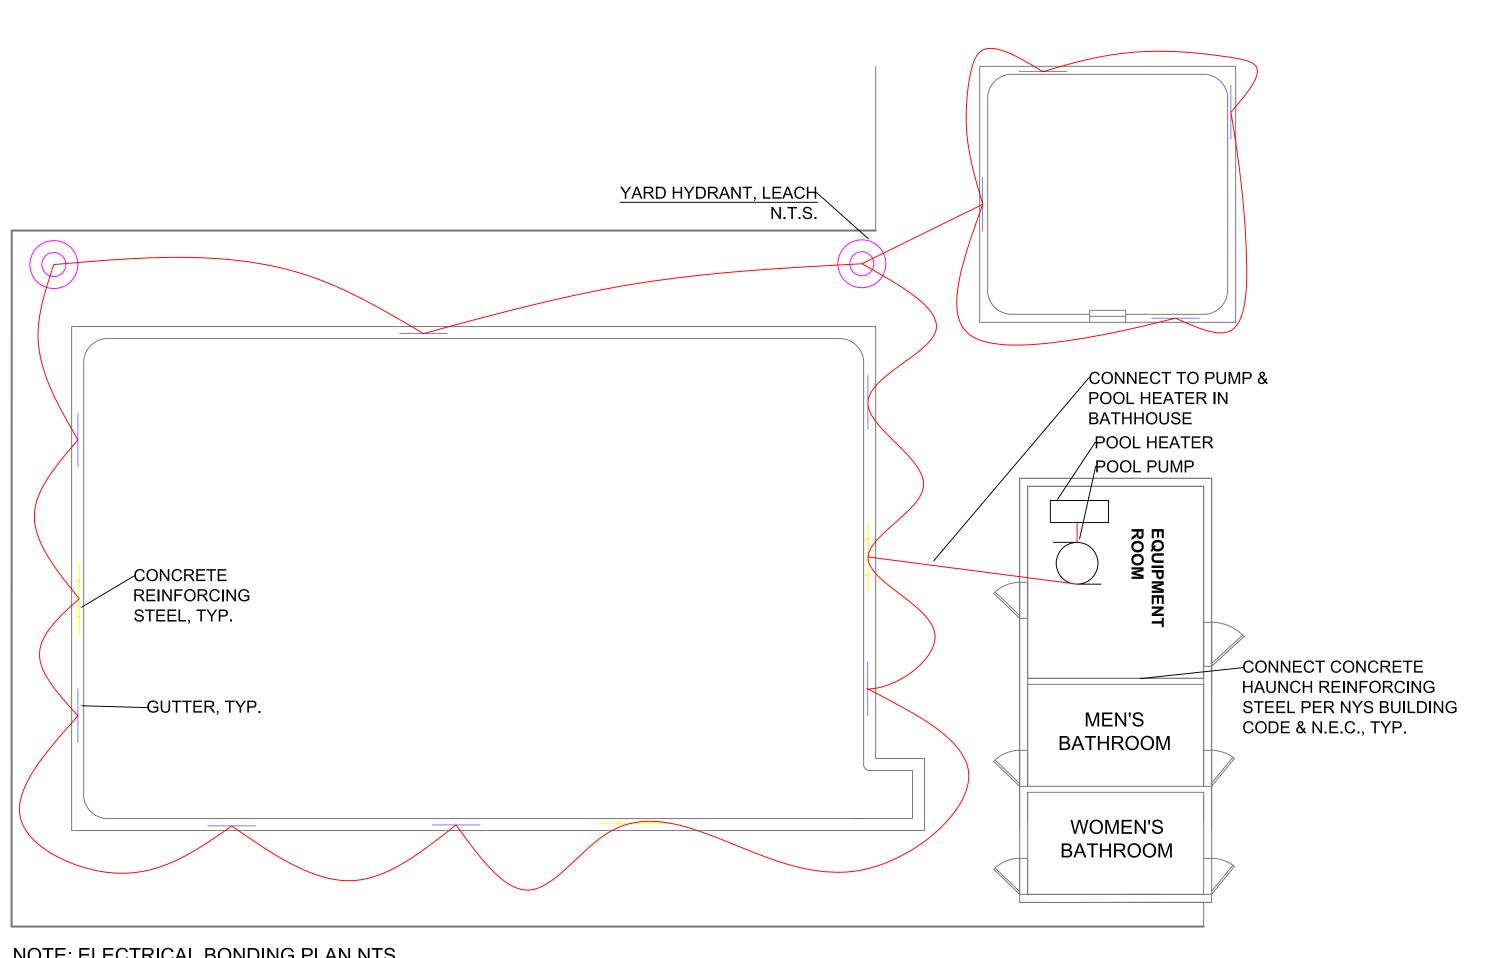

NOTE: ELECTRICAL BONDING PLAN NTS

- INSTALL PER NEC 2008, SECTION 680.26(C) REQUIREMENTS
- USE #8 COATED TAILS OF F BOUND LOOP TO EQUIPMENT AND STEEL NOT
- IMMEDIATELY ADJACENT TO BOND LOOP
- BOND ALL ANCHORS AT ALL HANDRAILS, GRABBERS, LADDERS, WATER GUTTERS(30' C-C), STANCHIONS, ETC. TYP.
- PROVIDE OWNER AND G.C. A COPY OF THE CERTIFIED UNDERWRITERS BONDING
- CERTIFICATE PRIOR TO START UP OF SYSTEM
- 5. ALL METAL USED IN THE TWO (2) POOLS' CONSTRUCTION SHALL BE BONDED IN ACCORD WITH NECESSARY INCLUDING ALL HANDRAIL, LADDER, GUTTER AND SO
- FORTH ELECTRICAL INSPECTION & APPROVAL REQUIRED

GENERAL ELECTRICAL NOTES:


THE ELECTRICAL CONTRACTOR SHALL OBTAIN INFORMATION ABOUT THE EXISTING UNDERGROUND UTILITIES FROM LOCAL AUTHORITY (DELHI VILLAGE) RECORDS AND SHALL DETERMINE THE EXACT LOCATION AND ELEVATION OF EXISTING UTILITIES BY FIELD INVESTIGATION.

THE ELECTRICAL CONTRACTOR SHALL OBTAIN PERMITS FROM ALL FEDERAL, STATE, AND/OR LOCAL PERMIT AUTHORITY HAVING JURISDICTION OVER ANY PHASE OF CONSTRUCTION ASSOCIATED WITH THE INSTALLATION.

THE ELECTRICAL CONTRACTOR SHALL MAINTAIN THE CONSTRUCTION SITE IN A NON-HAZARDOUS CONDITION IN ACCORDANCE WITH THE REQUIREMENT OF THE NEW YORK STATE DEPARTMENT OF LABOR, OSHA, AND ALL OTHER AGENCIES HAVING JURISDICTION. UNLESS OTHERWISE APPROVED IN WRITING BY DELHI TOWN, THE CONTRACTOR SHALL ERECT AND MAINTAIN ADEQUATE FENCING AROUND ALL OPEN EXCAVATION.


ALL WIRING AND CONDUIT INSTALLATION SHALL CONFORM TO NATIONAL ELECTRIC CODE (NEC) AND LOCAL REQUIREMENTS.

ALL INTERIOR ELECTRICAL CONDUIT SHALL BE EMT FASTENERS SHALL BE OF GALVANIZED STEEL CONSTRUCTION

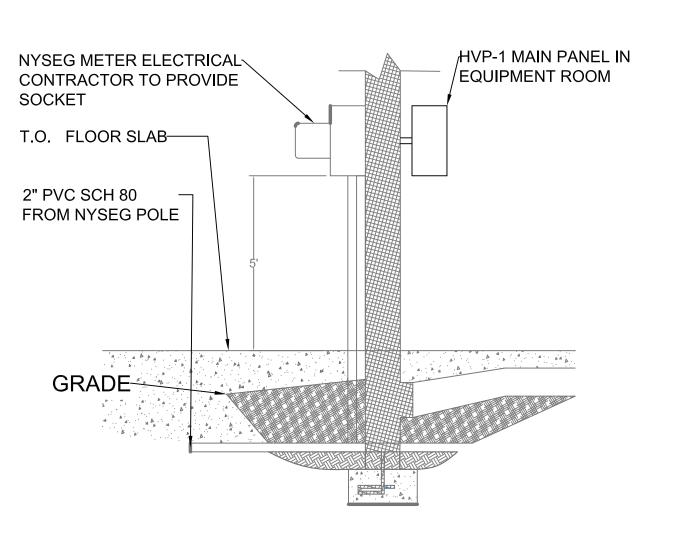


ELEC. METER ELEVATION

- POLE IS EXISTING, MODIFY TO CONFORM TO UTILITY COMPANY REQUIREMENTS. DISCONNECT AND REMOVE ABANDONED MATERIALS
- 2. PROVIDE 2" RIGID GALVANIZED CONDUIT TO A POINT 8' - 0" BELOW CROSS ARM ON POLE. PROVIDE 90° SWEEP UNDERGROUND AND RUN CONDUIT 8' -0" AT WHICH POINT CONNECT TO PVC CONDUIT. THE REMAINDER OF RUN TO BE 2" PVC SCH 80 **ELECTRICAL CONDUIT**
- PROVIDE ONE SPARE 3" SCH 80 PVC CONDUIT FROM TRANSFORMER TO 2'- 0" UP POLE ABOVE GRADE. CAP ENDS, INSTALL PULL WIRE
- 4. CONTRACTOR TO PROVIDE ALL NECESSARY MATERIALS TO RUN CONDUIT AND WIRE UP THE POLE AND SECURE TO POLE

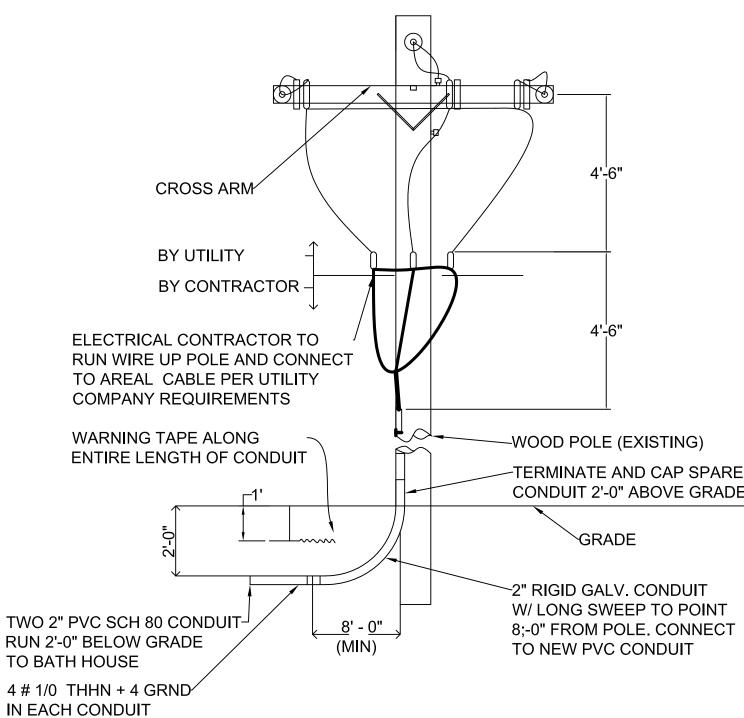


UTILITY POLE DETAIL NOT TO SCALE

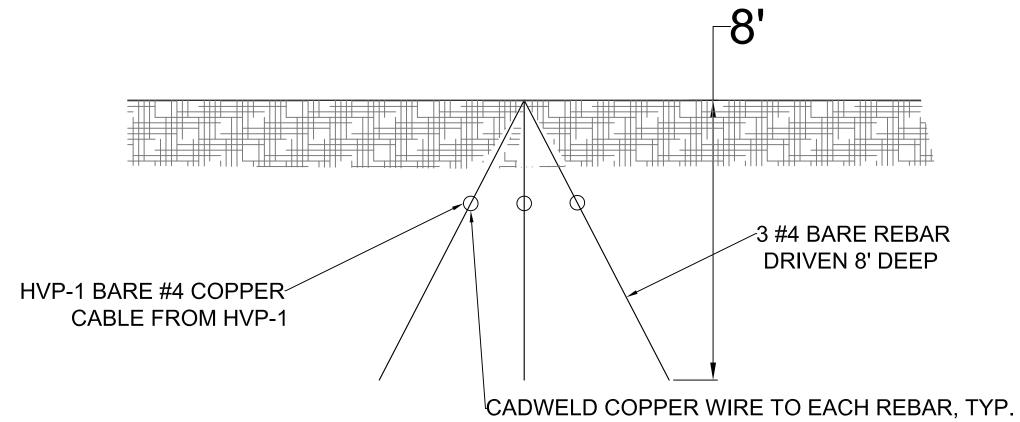

ELECTRICAL GROUNDING DETAIL N.T.S.

REQUIRED FOR HDPE PIPE WATER SERVICE ONLY. USE 2" COPPER WATER SERVICE FOR ALTERNATE ELECTRICAL GROUND METHOD, INSTALLED BY E.C, CONTRACT E-1 AT P-1 EXPENSE IF HDPE

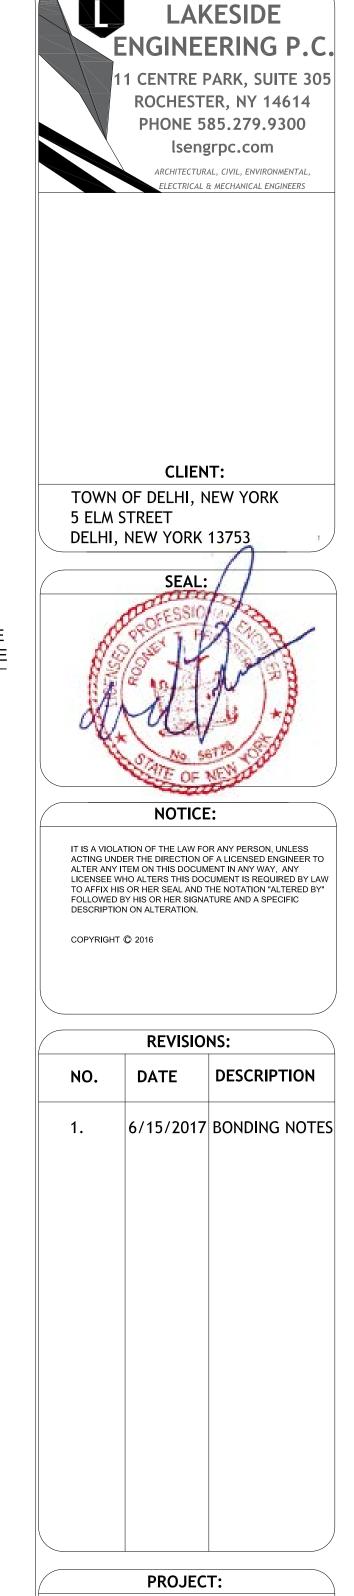

TOWN OF DELHI, NEW YORK MUNICIPAL SWIMMING POOL & BATH HOUSE PROJECT

DRAWING TITLE:

ELECTRICAL PLAN & FILTER **ROOM SUB-PANEL SCHEDULE**

DRAWING NO: 07/27/17 **AS SHOWN** SECTION NO.

DRAWN BY: J.X. SHEET NO. REVIEWED BY: R.P.

E-2/24 JOB ID: DT016-001